






0505-592.1 N.H.

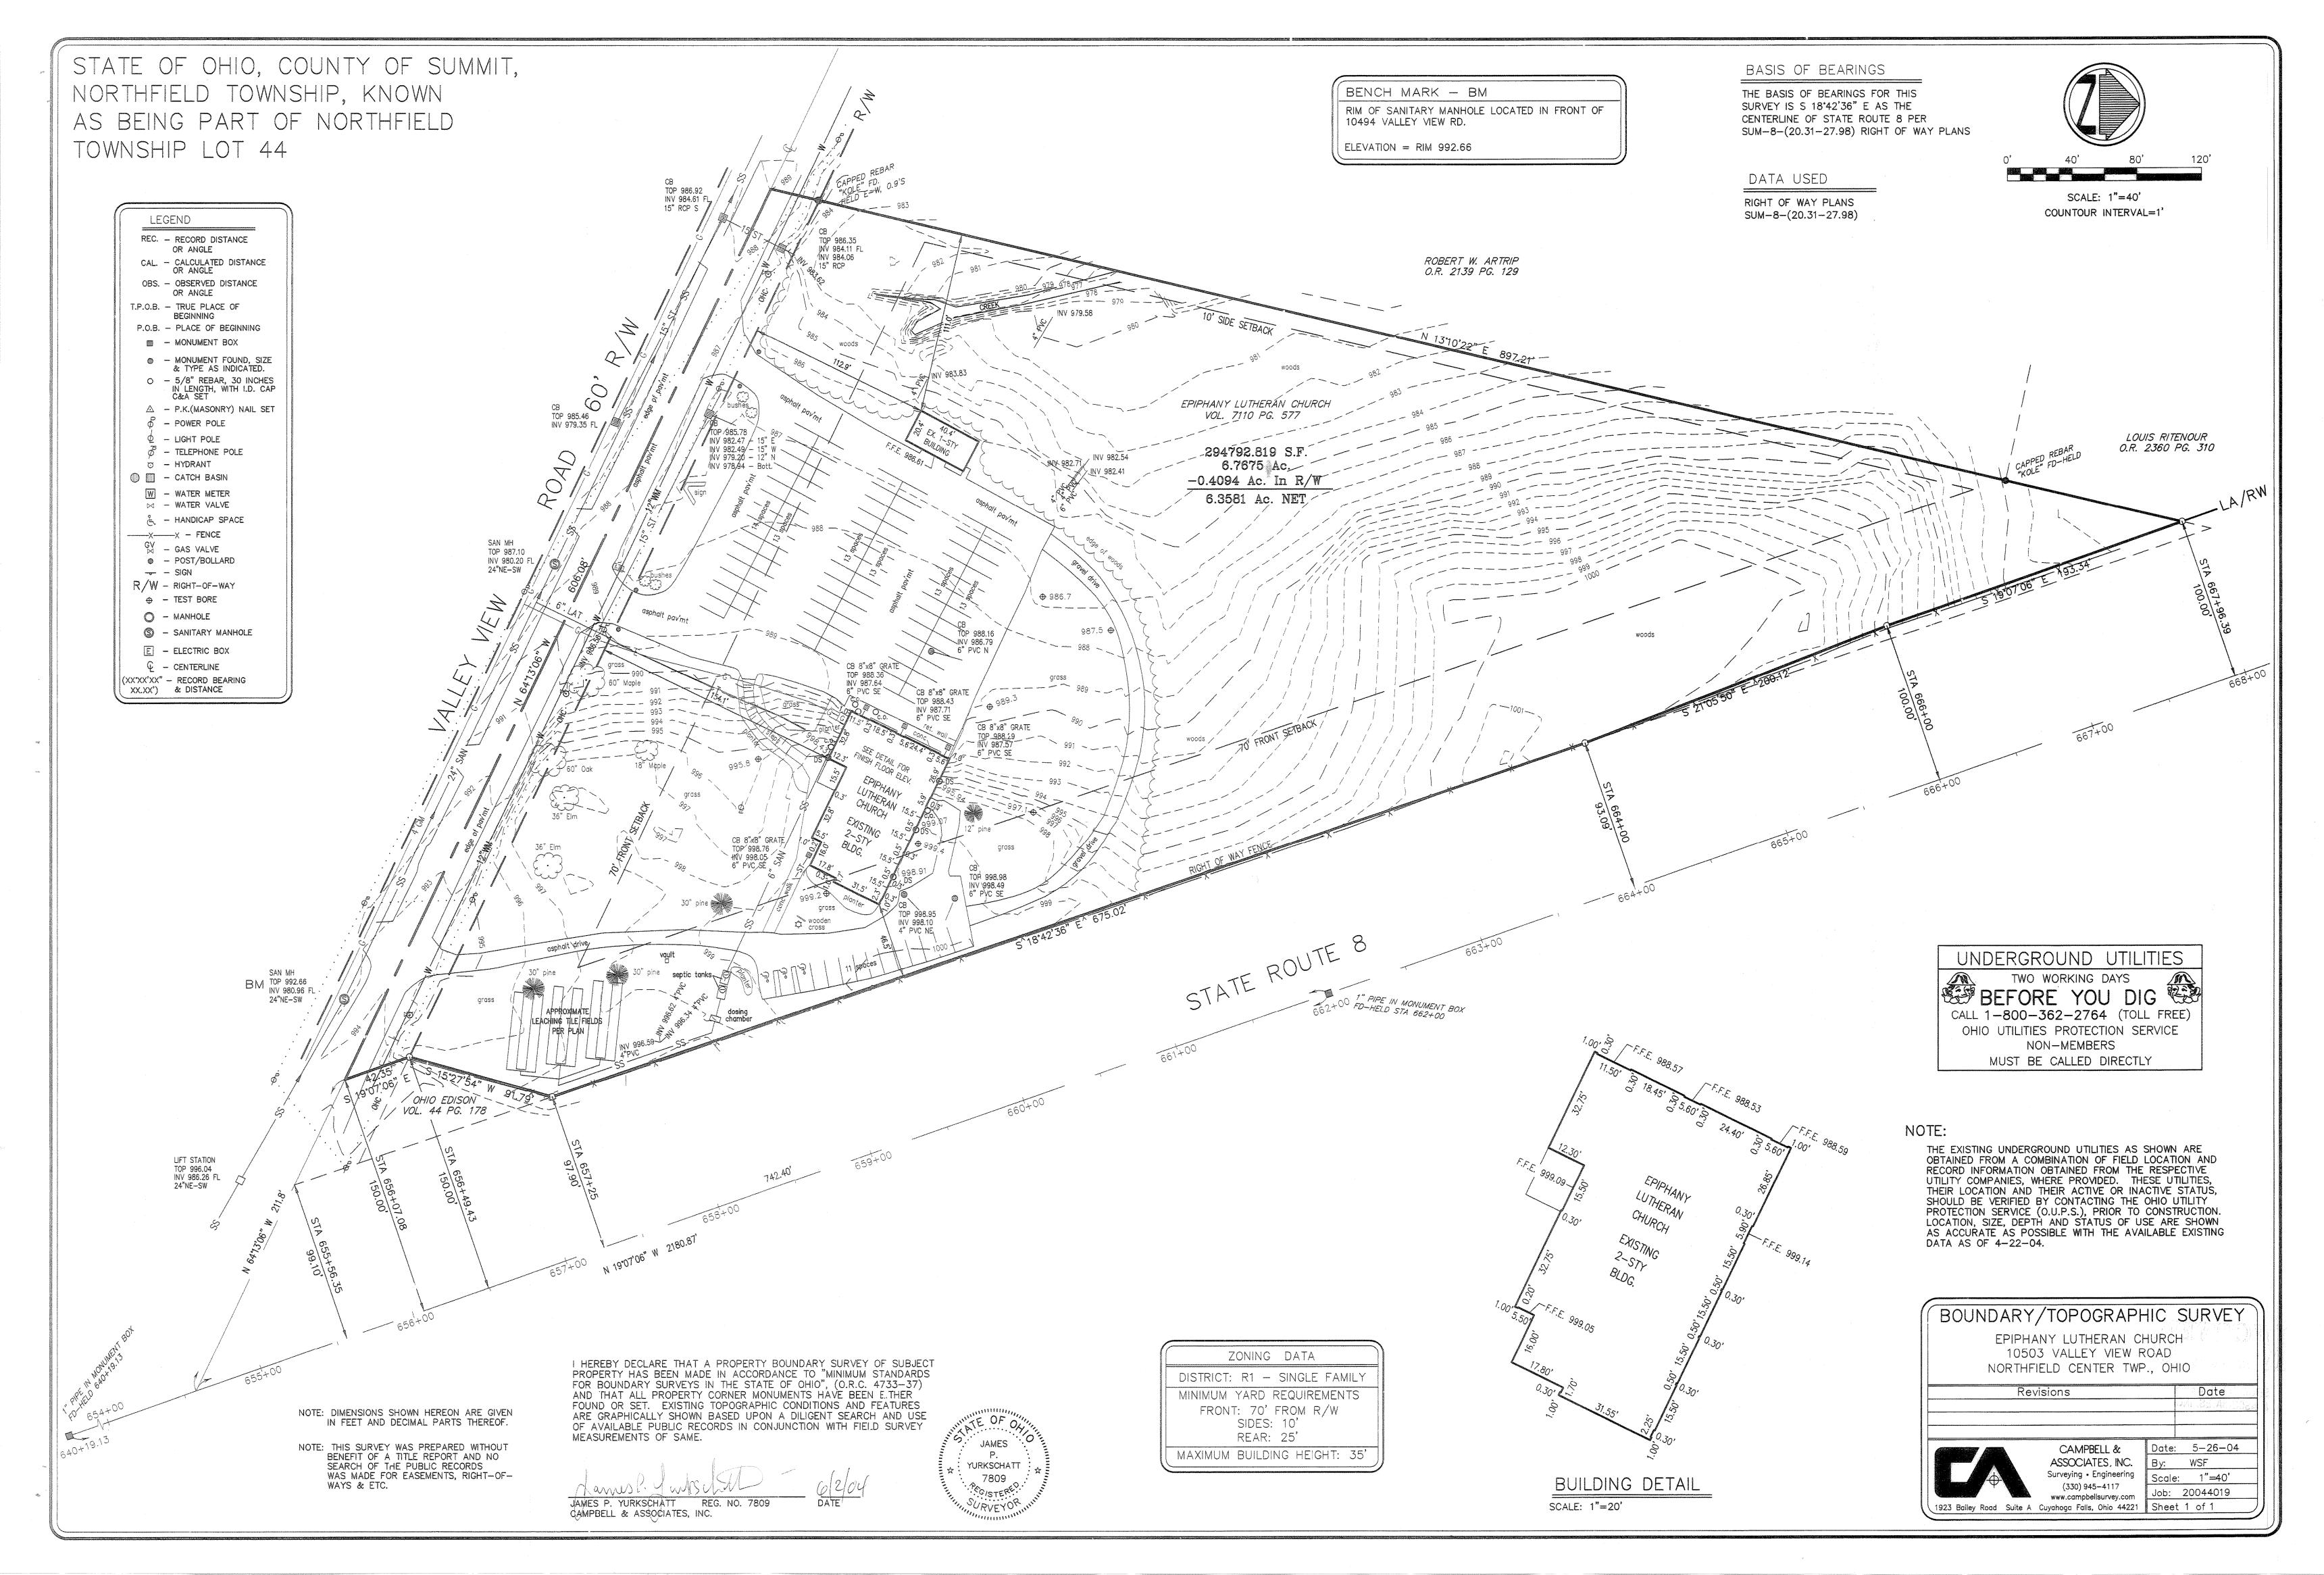

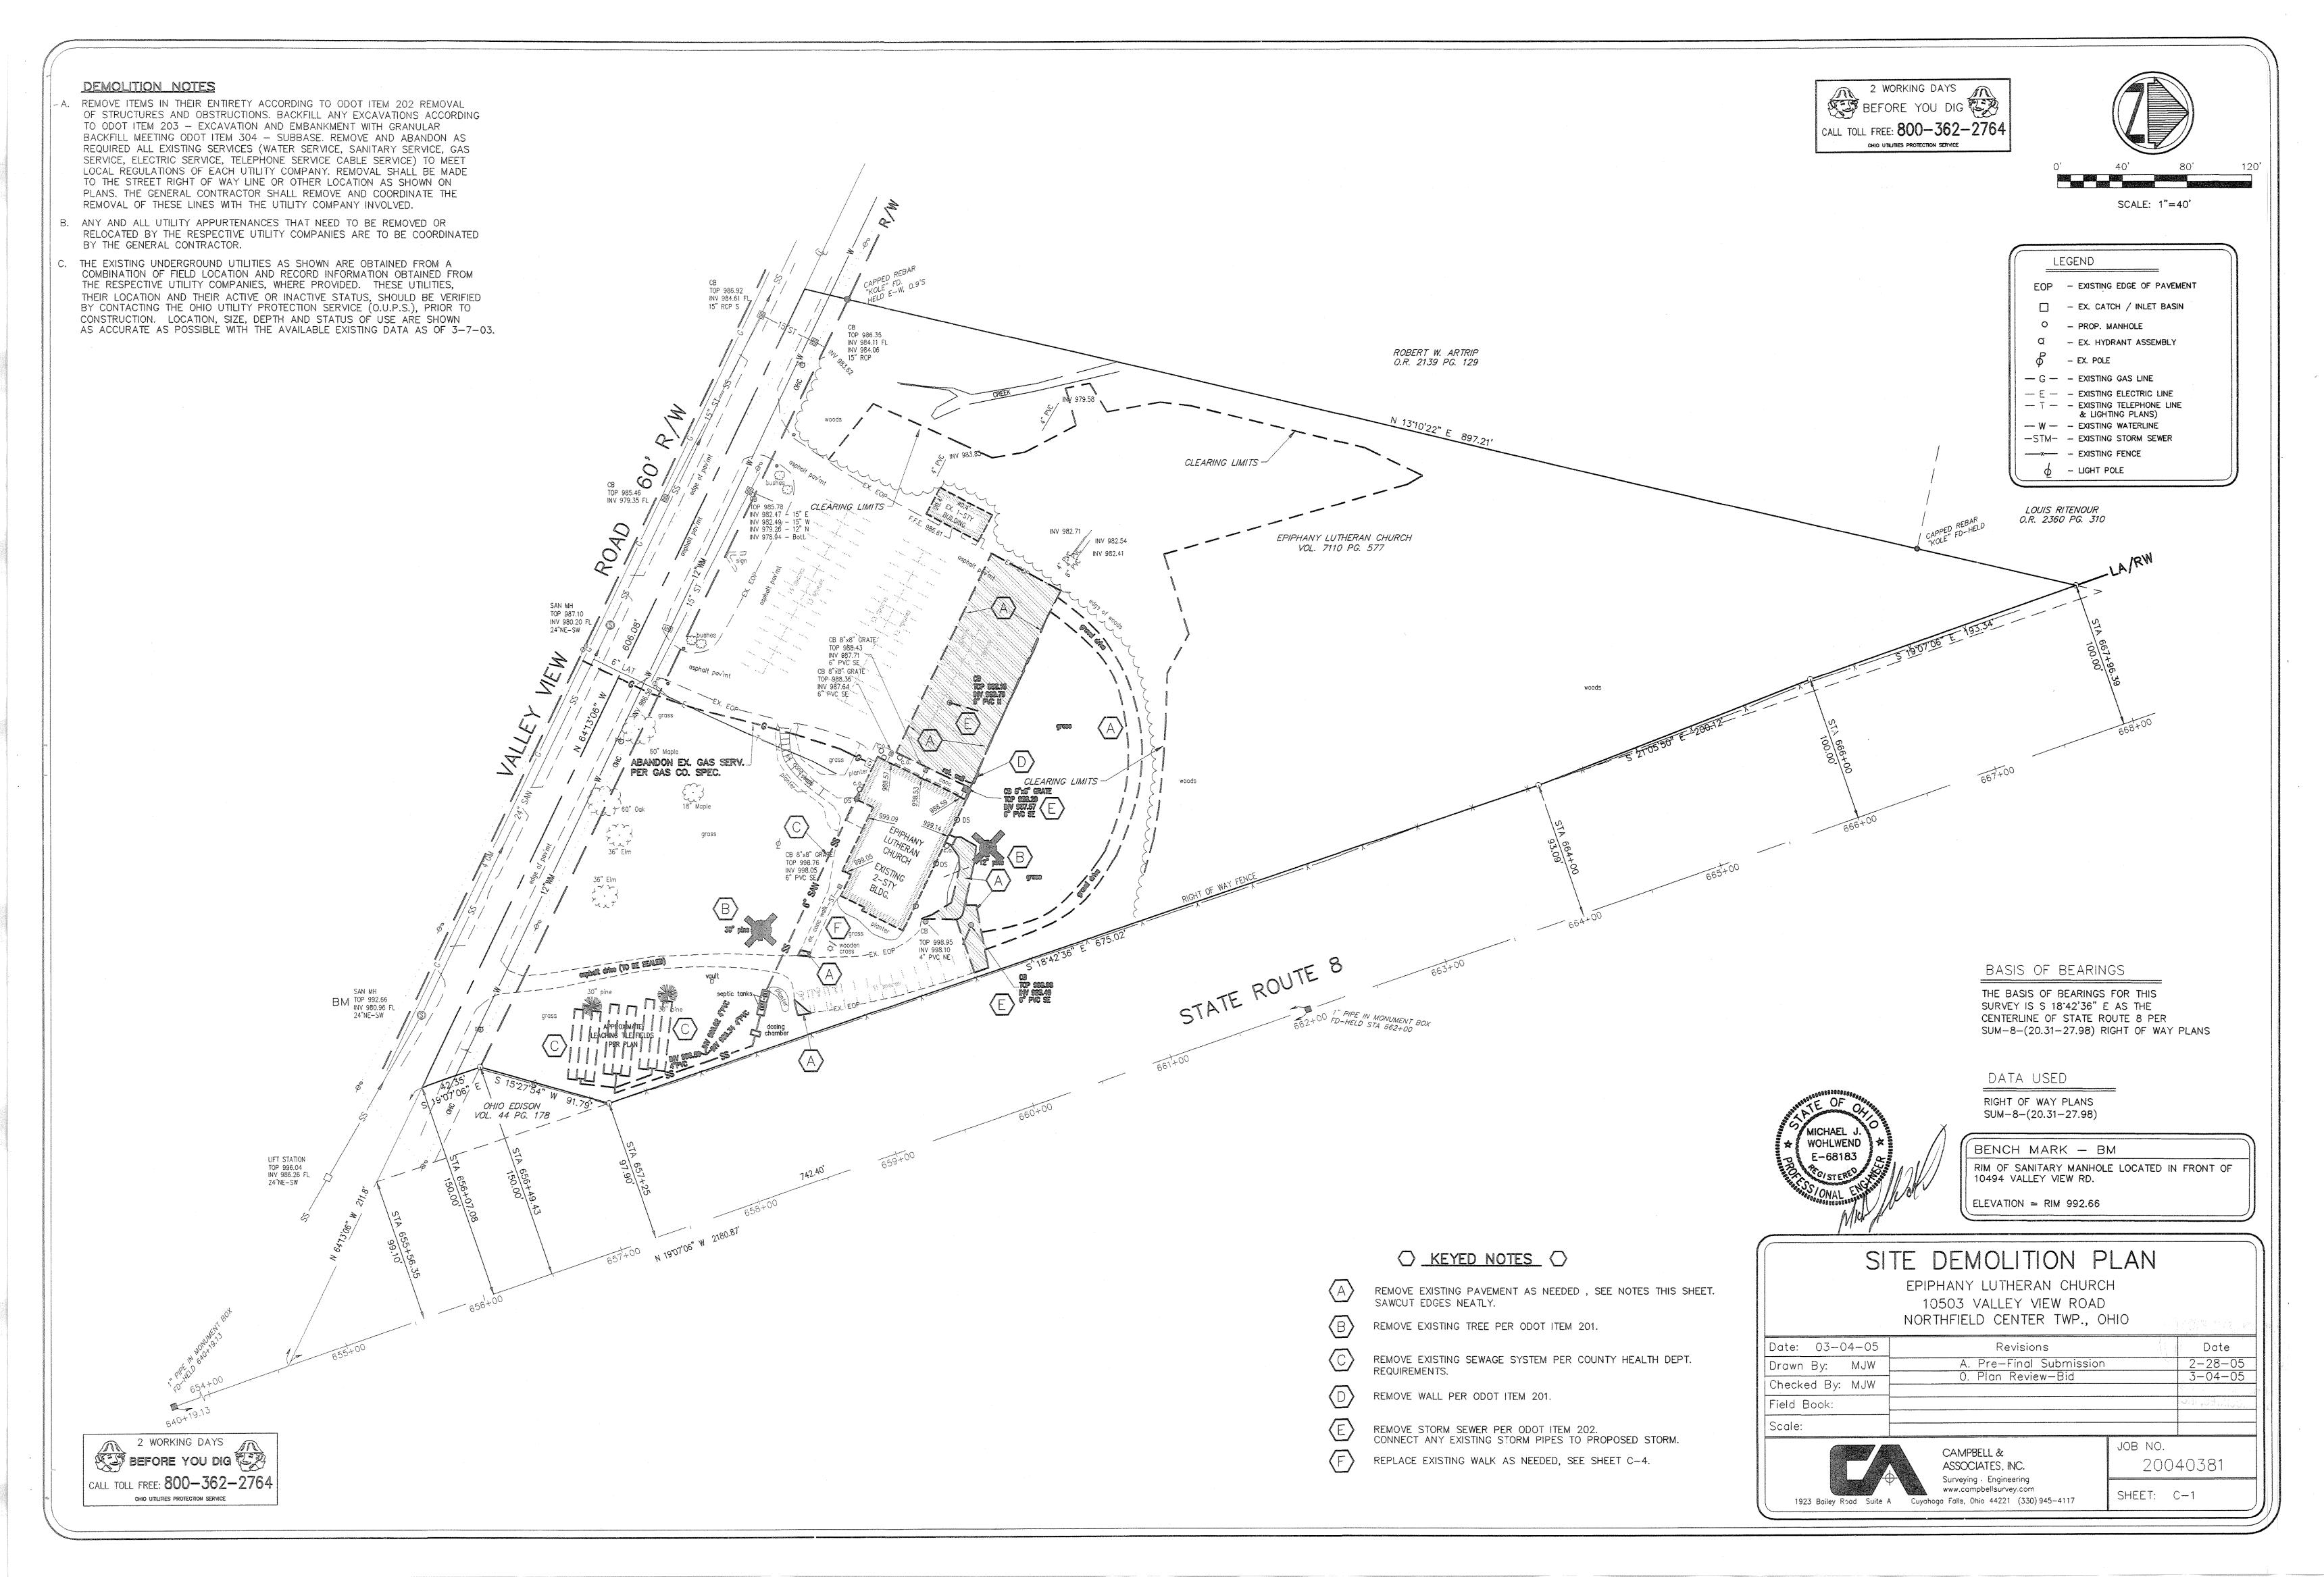

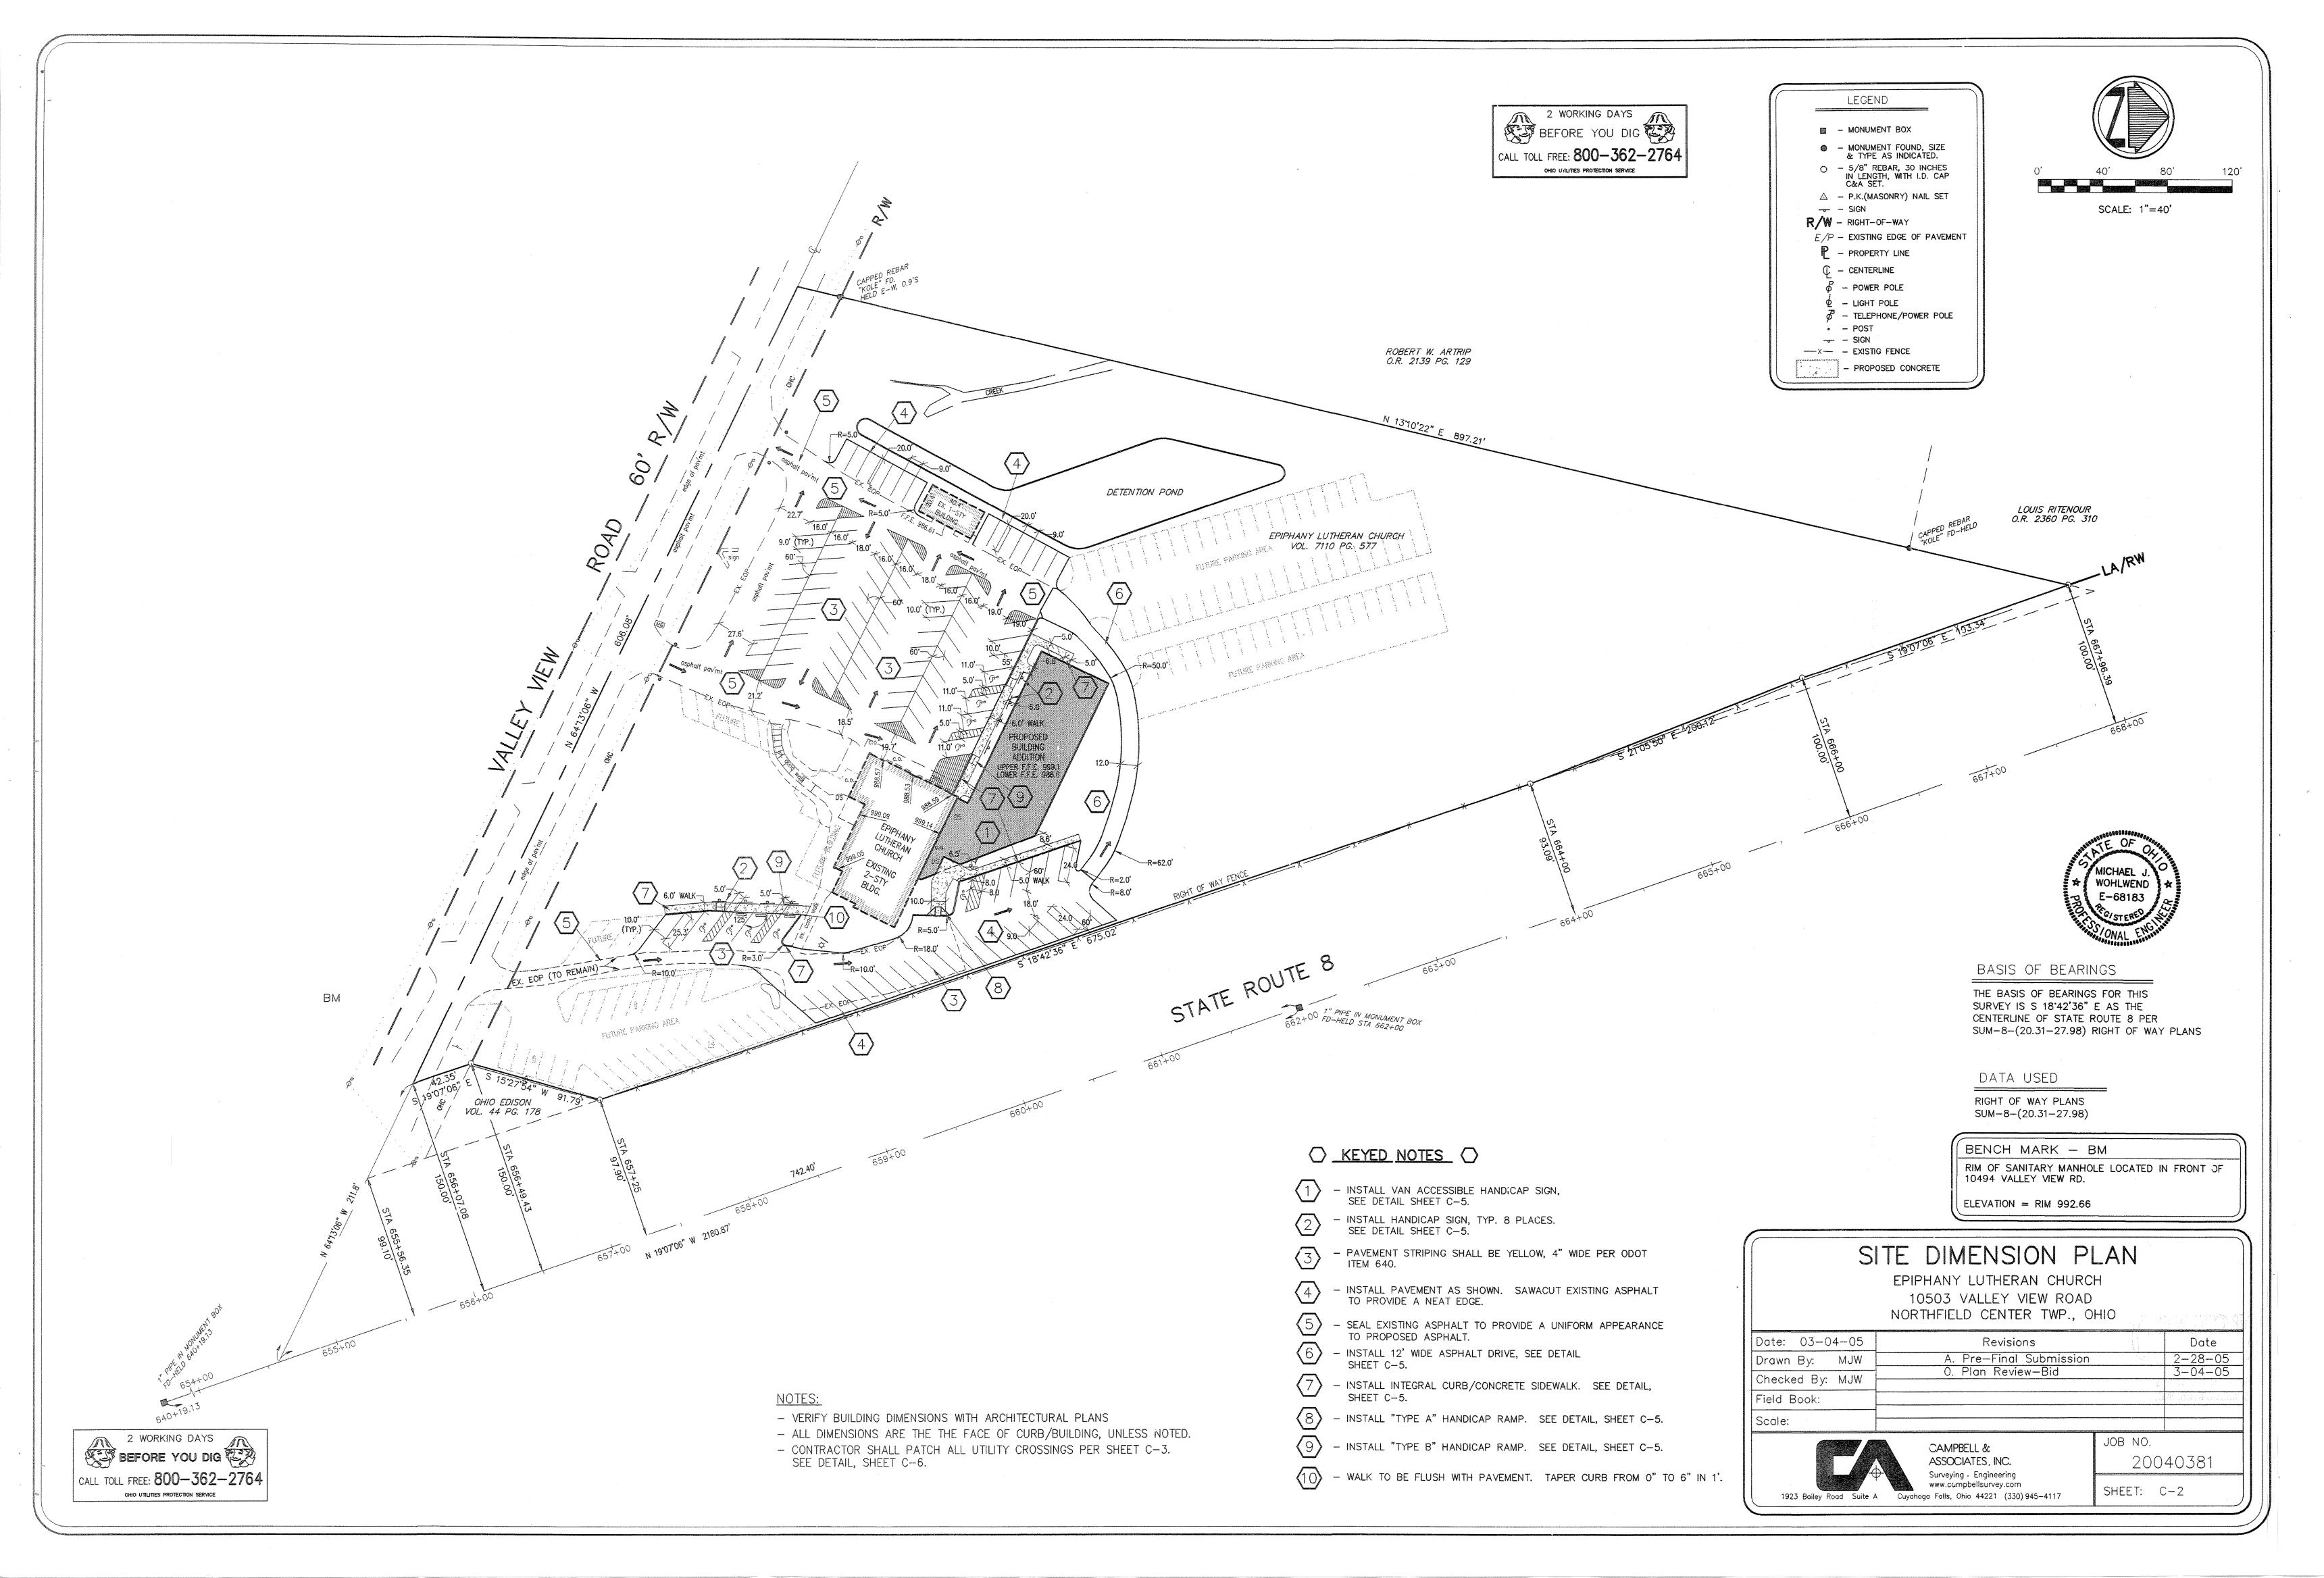

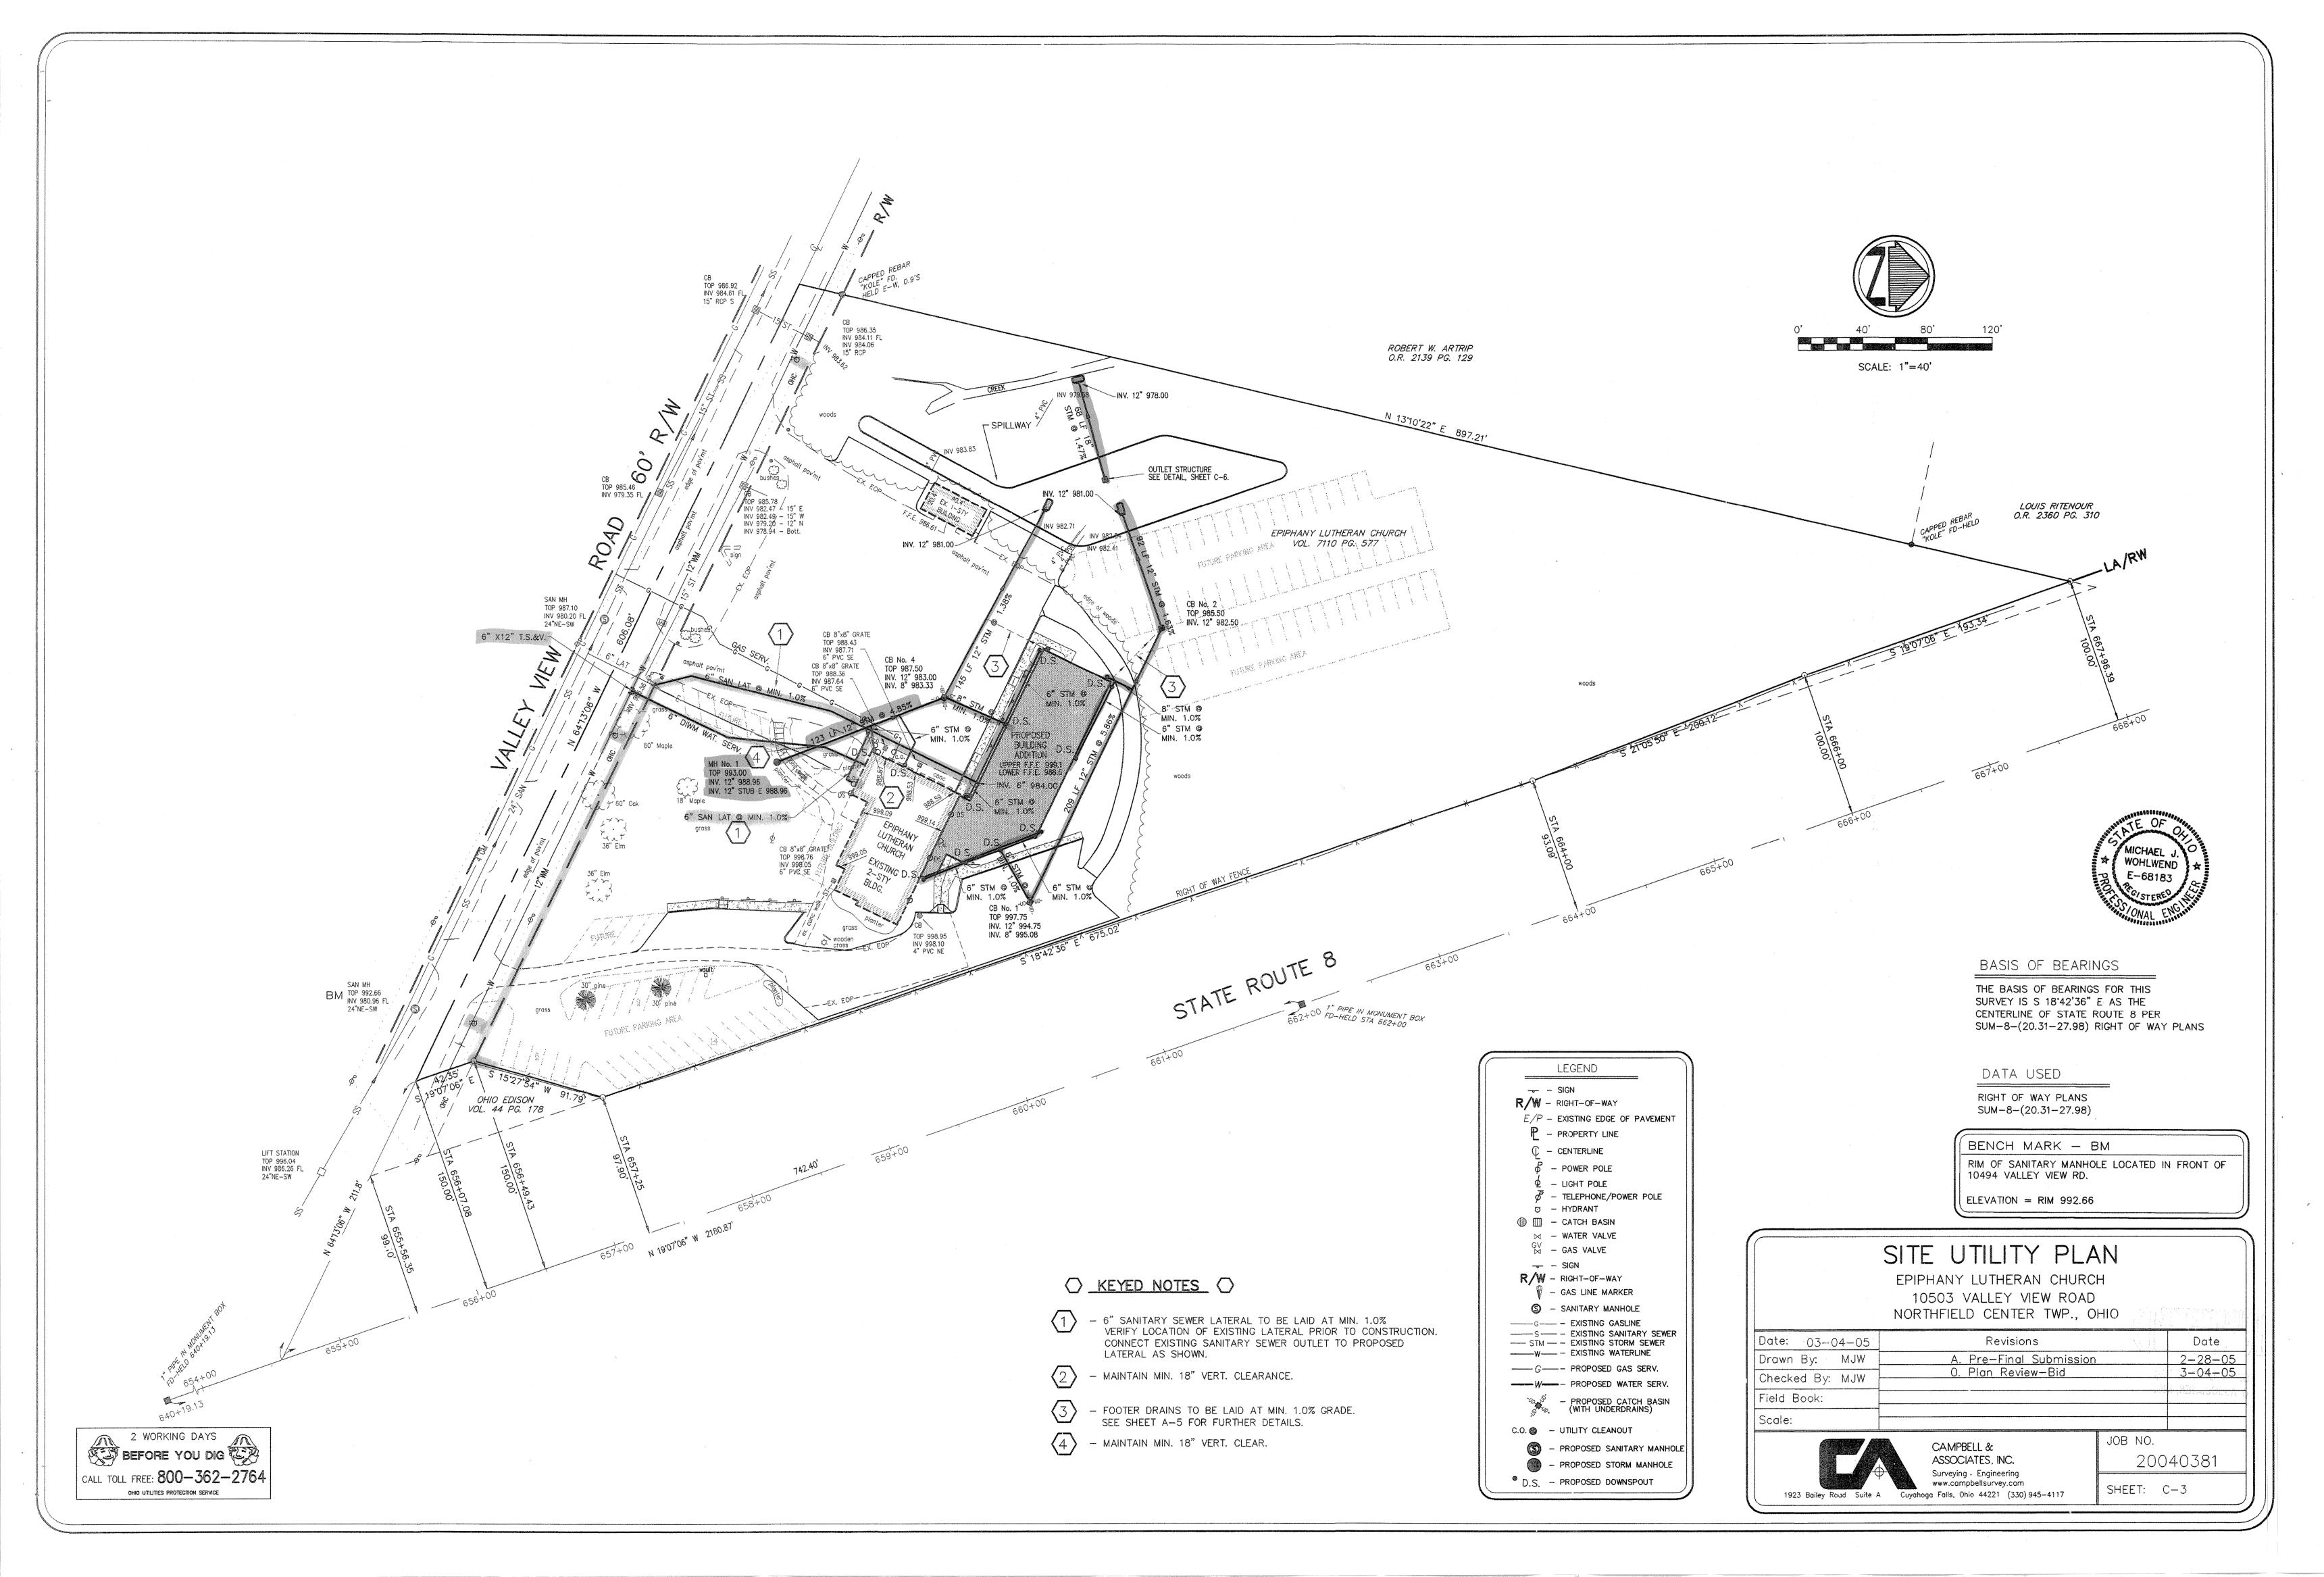

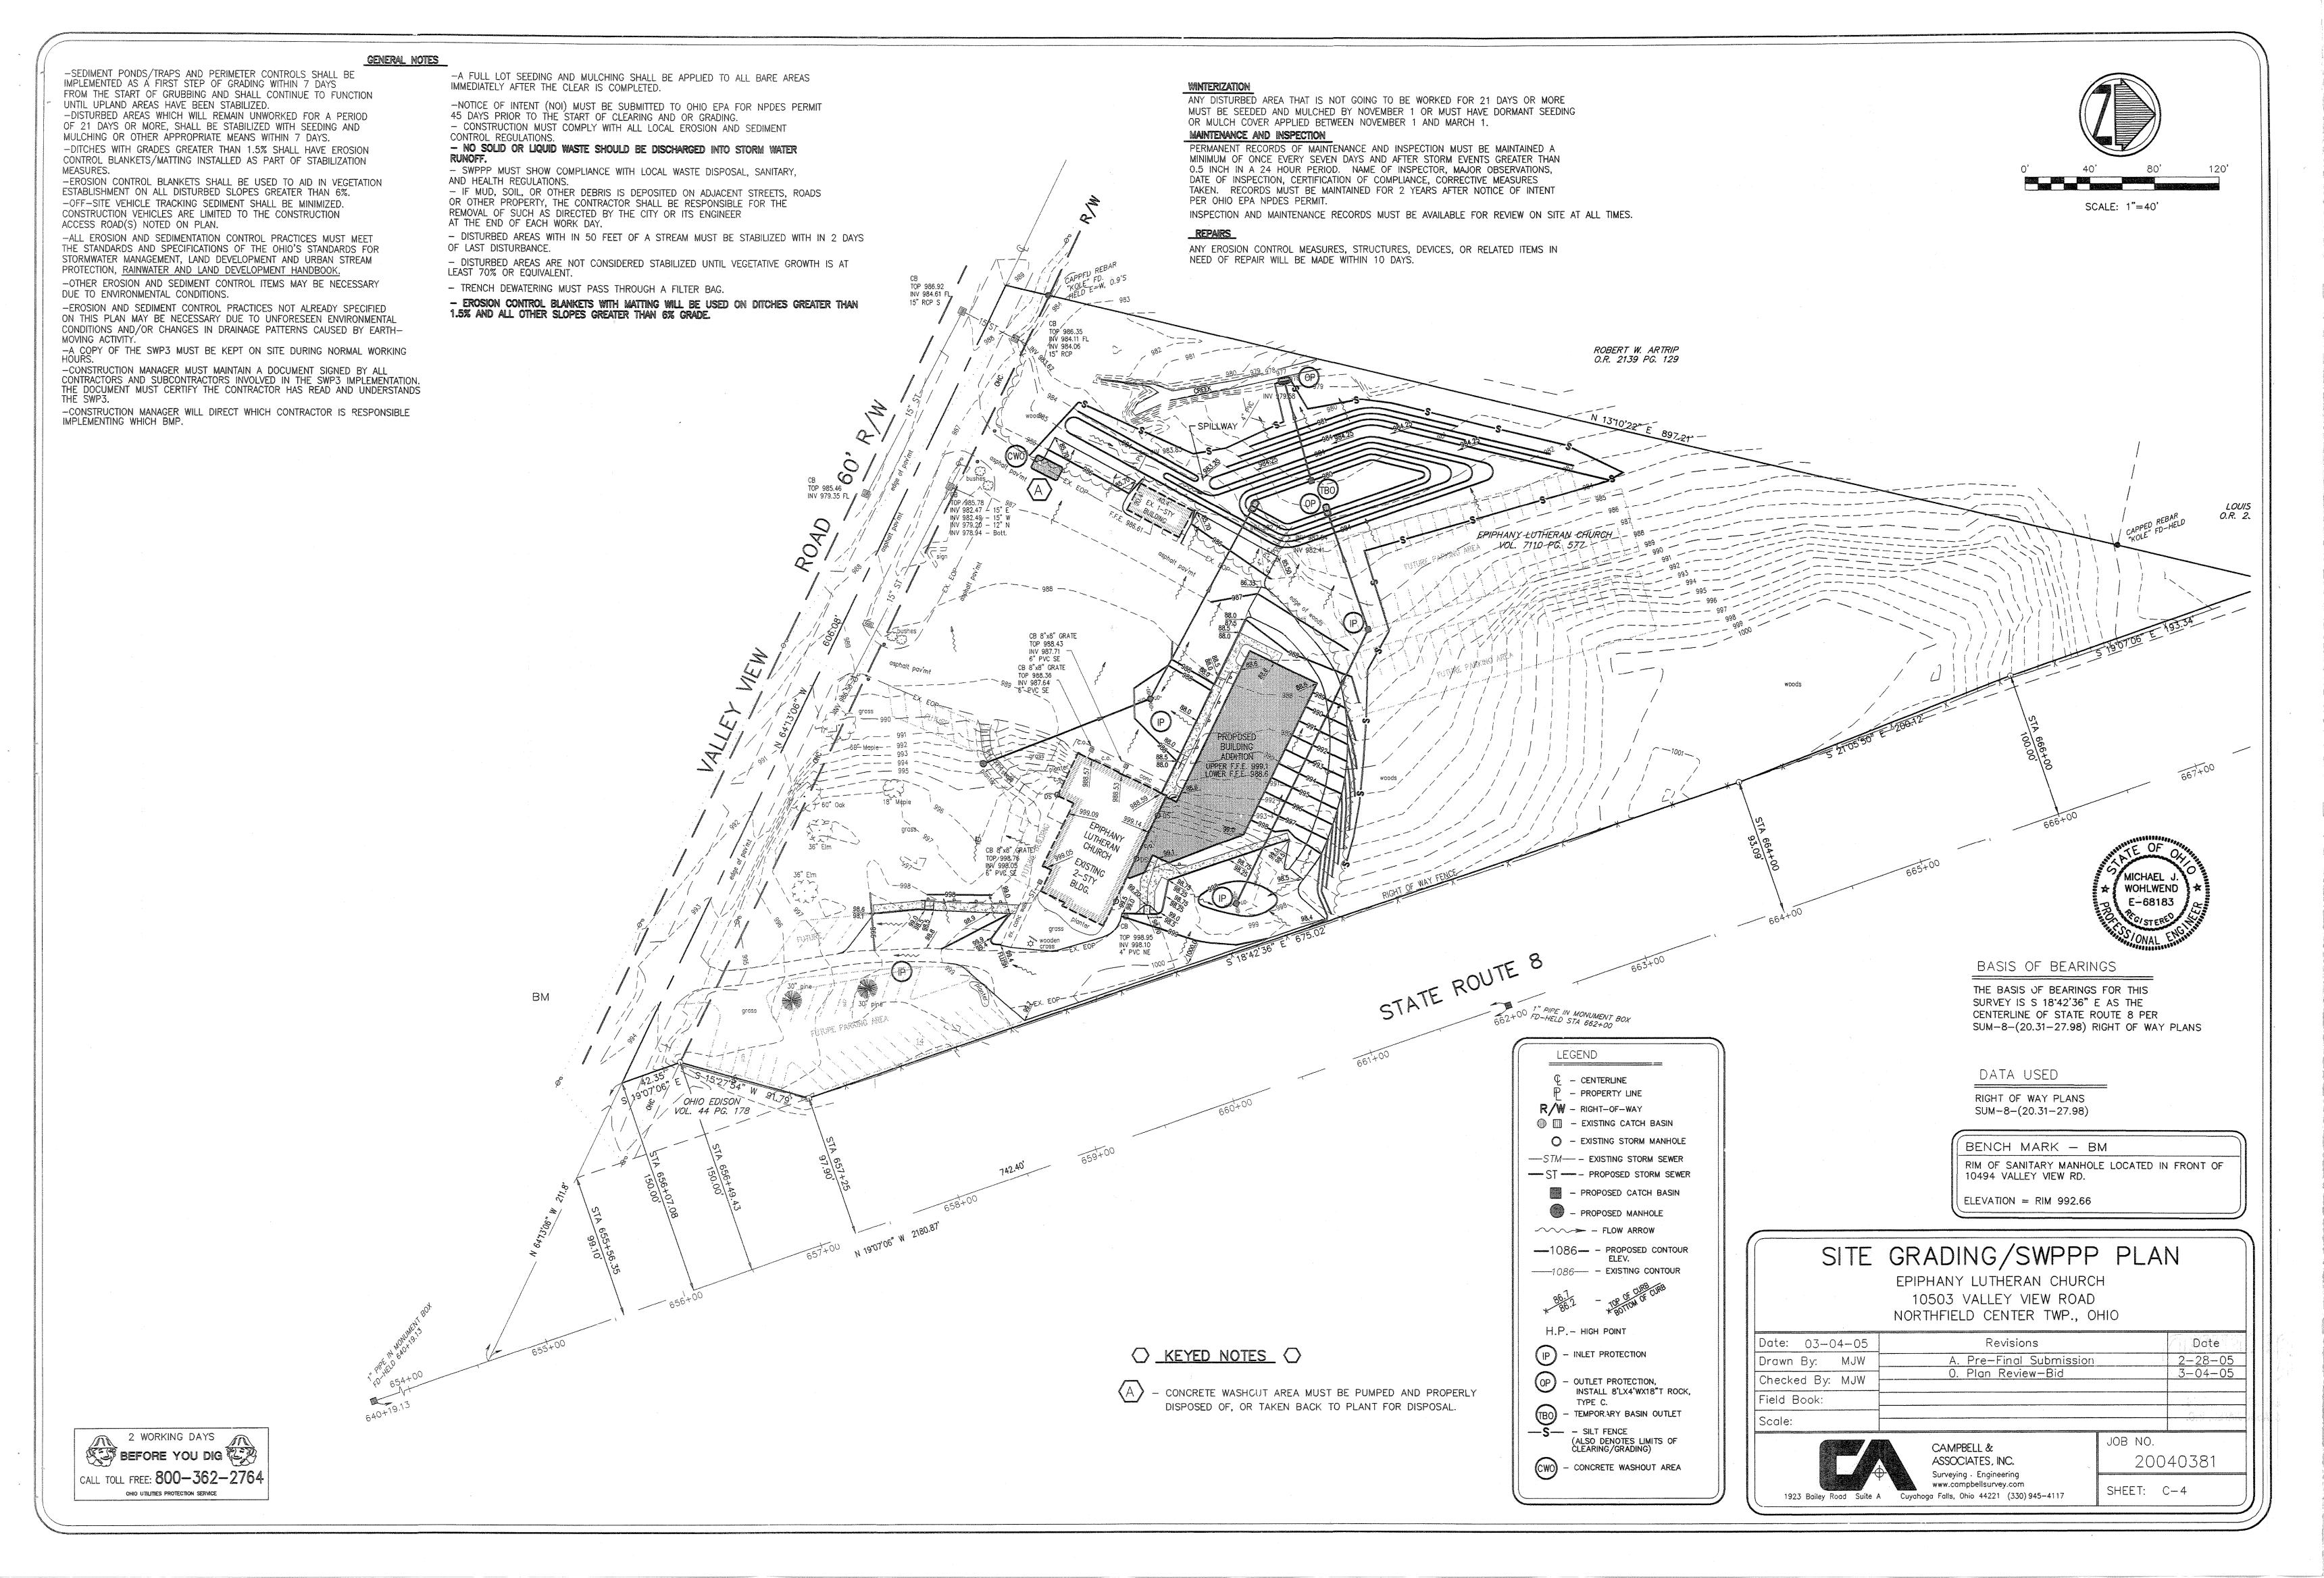

GENERAL NOTES

1. THE COUNTY OF SUMMIT REQUIREMENTS TOGETHER WITH THE LATEST EDITION OF THE STATE OF OHIO, DEPT. OF TRANSPORTATION CONSTRUCTION AND MATERIAL SPECIFICATIONS (CMS) SHALL GOVERN ALL CONSTRUCTION ITEMS THAT ARE A PART OF THIS PLAN, UNLESS OTHERWISE NOTED. IF THERE ARE ANY DISCREPANCIES, THE COUNTY REQUIREMENTS SHALL GOVERN. ALL FIELD TESTING SHALL BE THE RESPONSIBILITY OF THE CONTRACTOR (MATERIAL COMPOSITION, MATERIAL COMPACTION, CONCRETE TESTING, ETC.).

2. ANY MODIFICATION TO THE SPECIFICATIONS OR CHANGES TO THE WORK AS SHOWN ON THESE DRAWINGS MUST HAVE PRIOR WRITTEN APPROVAL OF THE COUNTY ENGINEER.

3. THE CONTRACTOR AND SUBCONTRACTOR SHALL BE SOLELY RESPONSIBLE FOR COMPLYING WITH ALL FEDERAL, STATE, AND LOCAL SAFETY REQUIREMENTS, TOGETHER WITH EXERCISING PRECAUTIONS AT ALL TIMES FOR THE PROTECTION OF PERSONS (INCLUDING EMPLOYEES) AND PROPERTY. IT IS ALSO THE SOLE RESPONSIBILITY OF THE CONTRACTOR AND SUBCONTRÀCTOR TO INITIATE, MÁINTAIN AND SUPERVISE ALL SAFETY REQUIREMENTS, PRECAUTIONS, AND PROGRAMS IN

4. THE CONTRACTOR SHALL NOTIFY THE COUNTY AT LEAST TWO (2) WORKING DAYS PRIOR TO COMMENCING CONSTRUCTION. 5. THE CONTRACTOR SHALL OBTAIN ALL NECESSARY PERMITS, PRIOR TO CONSTRUCTION.

6. EXISTING UTILITIES SHOWN ARE FROM BEST AVAILABLE RECORDS AND FIELD INVESTIGATION, AND ARE NOT NECESSARILY COMPLETE OR EXACT. THE CONTRACTOR IS RESPONSIBLE FOR THE INVESTIGATION, LOCATION, SUPPORT, PROTECTION, AND RESTORATION OF ALL EXISTING UTILITIES AND APPURTENANCES WHETHER SHOWN ON THESE PLANS OR NOT. THE CONTRACTOR SHALL EXPOSE ALL UTILITIES OR STRUCTURES PRIOR TO CONSTRUCTION TO VERIFY THE VERTICAL AND HORIZONTAL EFFECT ON THE PROPOSED CONSTRUCTION, AND SHALL MAKE ADJUSTMENTS IN ELEVATIONS TO PROVIDE SUFFICIENT CLEARANCE BETWEEN THE PROPOSED AND EXISTING UTILITIES. THE CONTRACTOR SHALL CALL THE OHIO UTILITIES PROTECTION SERVICE (1-800-362-2764) THREE WORKING DAYS PRIOR TO WORK

7. ANY PROPERTY CORNER PINS OR PERMANENT SURVEY MARKINGS DISTURBED DURING CONSTRUCTION SHALL BE RESET BY A REGISTERED SURVEYOR AT THE CONTRACTOR'S EXPENSE.

8. THE TRACKING OR SPILLAGE OF MUD, DIRT, OR DEBRIS UPON STREETS IS PROHIBITED AND ANY SUCH OCCURRENCE SHALL BE CLEANED UP IMMEDIATELY BY THE CONTRACTOR. IF THE CONTRACTOR FAILS TO KEEP THE WORK AREA CLEAN OF DEBRIS, OR FAILS TO CLEAN MUD OR DIRT OFF OF STREETS, THE COUNTY MAY TAKE ACTION AND ASSESS THE DEVELOPER FOR THE COSTS THAT ARE INCURRED.

9. NO NON-RUBBER TIRE VEHICLE SHALL BE MOVED ON STREETS; EXCEPTIONS MAY BE GRANTED WHERE SHORT DISTANCES AND SPECIAL CIRCUMSTANCES ARE INVOLVED. GRANTING OF EXCEPTIONS MUST BE IN WRITING AND ANY RESULTING DAMAGE MUST BE REPAIRED TO THE SATISFACTION OF THE COUNTY ENGINEER.

10. THE CONTRACTOR SHALL BE RESPONSIBLE FOR MAINTAINING MAIL SERVICE IN THE CONSTRUCTION AREA. 11. ALL ITEMS OF WORK CALLED FOR ON THE PLANS FOR WHICH NO SPECIFIC METHOD OF PAYMENT IS PROVIDED SHALL BE PERFORMED BY THE CONTRACTOR AND THE COST OF SAME SHALL BE INCLUDED IN THE PRICE BID FOR THE VARIOUS

RELATED ITEMS. 12. THE CONTRACTOR SHALL EXERCISE EXTREME CAUTION WHEN EXCAVATING IN THE VICINITY OF EXISTING TREES, TAKING ALL MEASURES POSSIBLE TO PROTECT AND PRESERVE THEM. THE CONTRACTOR SHALL BE GOVERNED BY THE PROVISIONS

OF HIS CONTRACT WITH THE OWNER. 13. ALL FIELD TILE BROKEN DURING EXCAVATION SHALL BE REPLACED TO ITS ORIGINAL CONDITION OR CONNECTED TO THE

STORM SEWER SYSTEM AS DIRECTED BY THE COUNTY ENGINEER. 14. APPROVAL OF THESE PLANS IS CONTINGENT ON ALL EASEMENTS REQUIRED FOR THE CONSTRUCTION OF THE WORK BEING SECURED AND SUBMITTED TO THE COUNTY FOR RECORDING PRIOR TO COMMENCEMENT OF THE WORK, AND NO WORK WHICH REQUIRES AN EASEMENT WILL BE ALLOWED TO PROCEED UNTIL THIS HAS BEEN DONE.

15. ALL TRAFFIC CONTROL DEVICES SHALL BE FURNISHED, ERECTED, MAINTAINED, AND REMOVED BY THE CONTRACTOR IN ACCORDANCE WITH THE OHIO MANUAL OF UNIFORM TRAFFIC CONTROL DEVICES PART 7 CONSTRUCTION AND MAINTENANCE OPERATIONS, COPIES OF WHICH ARE AVAILABLE FROM THE OHIO DEPARTMENT OF TRANSPORTATION, BUREAU OF TRAFFIC,

16. STEADY-BURNING, TYPE "C" LIGHTS SHALL BE REQUIRED ON ALL BARRICADES DRUMS AND SIMILAR TRAFFIC DEVICES IN USE AT NIGHT, CONES ARE NOT PERMITTED TO BE USED FOR NIGHT WORK,

17. ALL TRENCHES SHALL BE BACKFILLED OR SECURELY PLATED DURING NON WORKING HOURS.

18. ACCESS TO ALL ADJOINING PROPERTIES SHALL BE MAINTAINED AT ALL TIMES.

19. ALL AREAS WITHIN THE PUBLIC RIGHT-OF-WAY THAT ARE DISTURBED BY THIS PROJECT SHALL BE RESTORED TO ORIGINAL OR BETTER CONDITION, PER CMS ITEM 659 (SEEDING AND MULCHING) OR OTHER APPLICABLE SPECIFICATIONS.

20. AT ALL UTILITY CROSSINGS WHERE THE EXISTING UTILITY IS EXPOSED IN THE TRENCH, THE BACKFILL SHALL CONSIST OF COMPACTED GRANULAR MATERIAL IN ACCORDANCE WITH CMS ITEM 603 BETWEEN THE DEEPER AND SHALLOWER PIPE. WHERE PROPOSED UTILITIES OR SERVICES CROSS PROPOSED OR EXISTING PAVEMENT AREAS, BACKFILL SHALL BE COMPACTED GRANULAR MATERIAL IN ACCORDANCE WITH CMS ITEM 603 EXTENDING AT LEAST 3 FEET BEYOND THE BACK OF CURB OR EDGE OF PAVEMENT. COST IS TO BE INCLUDED IN THE PRICE BID FOR RELATED PIPE.

21. IN THE EVENT EXCAVATION FOR THE STREET IS FROM 0" TO 6" BELOW THAT CALLED FOR ON THE PLANS, THE CONTRACTOR SHALL REPLACE THIS EXCESS EXCAVATED MATERIAL WITH ITEM 304 AGGREGATE, AND SHALL BE PAID FOR BY THE CONTRACTOR.

22. CURB INLETS, MANHOLES, AND CATCH BASINS SHALL BE CHANNELED AS DIRECTED.

23. IT SHALL BE THE RESPONSIBILITY OF THE CONTRACTOR TO ADEQUATELY BARRICADE THE STREET IN THE VICINITY OF ALL EXPANSION JOINTS UNTIL SUCH TIME AS THE STREET IS OPEN TO TRAFFIC. 24. WHERE NECESSARY TO DISTURB PAVEMENTS OR DRIVES, THE PAVEMENT SHALL BE SAW CUT IN NEAT, STRAIGHT LINES.

THE DEPTH OF SAW CUT SHALL BE AT LEAST 2 INCHES. 25. THE COUNTY ENGINEER WILL NOT BE RESPONSIBLE FOR MEANS, METHODS, PROCEDURES, TECHNIQUES, OR CONSEQUENCES OF CONSTRUCTION THE COUNTY ENGINEER WILL NOT BE RESPONSIBLE FOR SAFETY ON THE JOB SITE, OR FOR FAILURE BY THE CONTRACTOR TO PERFORM WORK ACCORDING TO CONTRACT DOCUMENTS. 26. THE CONTRACTOR SHALL RESTRICT CONSTRUCTION ACTIVITY TO PUBLIC RIGHT-OF-WAY AND AREAS DEFINED AS

PERMANENT AND/OR TEMPORARY CONSTRUCTION EASEMENTS. 27. THE CONTRACTOR SHALL RESTORE ALL DISTURBED AREAS TO EQUAL OR BETTER CONDITION THAT EXISTED BEFORE CONSTRUCTION. DRAINAGE DITCHES OR WATER COURSES THAT ARE DISTURBED BY CONSTRUCTION SHALL BE RESTORED TO THE GRADES AND CROSS SECTIONS THAT EXISTED BEFORE CONSTRUCTION.

28. ALL SIGNS, LANDSCAPING, STRUCTURES, OR OTHER APPURTENANCES DISTURBED OR DAMAGED DURING CONSTRUCTION SHALL BE REPLACED OR REPAIRED TO THE SATISFACTION OF THE COUNTY ENGINEER. THE COST OF SUCH WORK SHALL BE 29. PERMITS TO CONSTRUCT IN THE RIGHT-OF-WAY OF EXISTING STREETS MUST BE OBTAINED FROM THE COUNTY BEFORE COMMENCING CONSTRUCTION. WHEN OPEN-CUTTING OF EXISTING PAVEMENT IS PERMITTED, CONTROLLED DENSITY BACKFILL

MAY BE USED IN PLACE OF COMPACTED GRANULAR BACKFILL. ASPHALT SURFACES SHALL BE HEAT WELDED. 30. WHEN UNKNOWN OR INCORRECTLY LOCATED UNDERGROUND UTILITIES ARE ENCOUNTERED DURING CONSTRUCTION, THE CONTRACTOR SHALL IMMEDIATELY NOTIFY THE OWNER AND THE COUNTY ENGINEER. 31. BEFORE RELOCATING ANY MAILBOXES, THE CONTRACTOR SHALL CONTACT THE U.S. POSTAL SERVICE AND RELOCATE

MAILBOXES ACCORDING TO THE REQUIREMENTS OF THE POSTAL SERVICE. 32. ALL BENCHMARKS ARE BASED ON UNITED STATES GEOLOGICAL SURVEY (USGS) DATUM.

1. ROOF DRAINS, FOUNDATION DRAINS, AND OTHER CLEAN WATER CONNECTIONS TO THE SANITARY SEWER SYSTEM ARE PROHIBITED ON THIS PROJECT.

2. ALL SEWERS CONSTRUCTED UNDER THIS PLAN SHALL MEET THE REQUIREMENTS OF CMS ITEM 603. 3. THE MINIMUM REQUIREMENTS FOR SANITARY PIPE SHALL BE PVC PLASTIC SEWER PIPE, ASTM D-3034, SDR 35. ALL 6" SANITARY LATERAL SHALL BE LAID AT A MINIMUM GRADE OF 1.0%.

1. ALL WATER SERVICE MATERIALS AND INSTALLATIONS SHALL BE IN ACCORDANCE WITH THE CURRENT RULES AND REGULATIONS OF THE LOCAL WATER DEPARTMENT.

2. WATER SERVICE SHALL BE LAID WITH A MINIMUM OF 4'- 6" FROM THE TOP OF FINISHED GRADE TO THE TOP OF THE

3. MINIMUM CLEARANCE BETWEEN SANITARY SEWER AND WATER LINES SHALL BE 10' HORIZONTAL OR 1'-6" VERTICAL

4. IF THE TOP OF THE OPERATING NUT FOR ANY VALVE IS MORE THAN 36" BELOW THE FINISHED GRADE, AN EXTENSION STEM SHALL BE PROVIDED TO PLACE THE OPERATING NUT BETWEEN 24" AND 36" OF THE FINISHED GRADE. ALL WATER VALVES SHALL CONFORM TO THE COUNTY OF SUMMIT WATER DEPARTMENT MATERIAL SPECIFICATIONS. 5. THE CONTRACTOR SHALL NOTIFY THE COUNTY OF SUMMIT WATER DEPT. AT LEAST TWO WORKING DAYS BEFORE


6. A TAP PERMIT FOR EACH WATER SERVICE TAP MUST BE OBTAINED PRIOR TO ANY WORK.

7. WATER SERVICES 2" AND UNDER SHALL BE SOFT TYPE "K" COPPER WITH FLARED FITTING. ALL SERVICES BETWEEN 2" - 6" SHALL BE CLASS 160 PVC, SDR 26 OR DUCTILE IRON. ALL SERVICES 6" AND LARGER SHALL BE DUCTILE IRON.

8. BOOSTER PUMPS ARE NOT PERMITTED ON SERVICE CONNECTIONS. 1. ALL STORM SEWER PIPES TO BE ITEM 603, CONDUIT TYPE B. E.ACKFILL UNDER PAVEMENT SHALL BE GRANULAR MATERIAL PAYMENT FOR


COMPACTED GRANULAR BACKFILL MATERIAL SHALL BE INCLUDED IN THE PRICE BID FOR ITEM 603. 2. ALL STORM SEWFR TO HAVE TYPE | BEDDING.

3. ALL STORM SEWER CONSTRUCTED UNDER THIS PLAN SHALL MEET THE REQUIREMENTS OF ODOT CMS ITEM 603. 4. ALL STORM SEWER SHALL BE HDPE PIPE (ODOT 707.33) WITH PREMIUM O-RING GASKETS, WHERE NOTED.

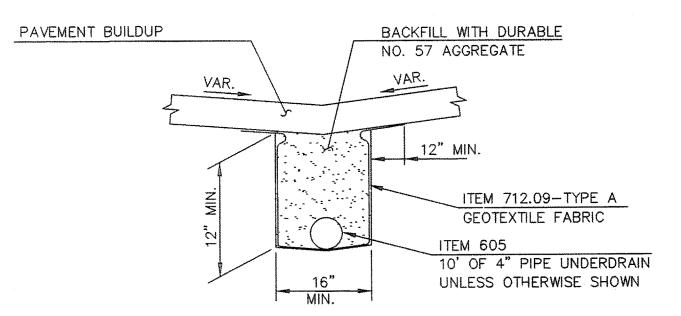

NOTES: PAYMENT FOR UNDERDRAIN SHALL BE INCLUDED IN THE PRICE BID FOR ITEM 604. PROVIDE UNDERDRAIN CONNECTIONS PER LOCATION AND QUANTITY SHOWN ON GRADING AND DRAINAGE PLAN.

UNDERDRAIN DETAIL

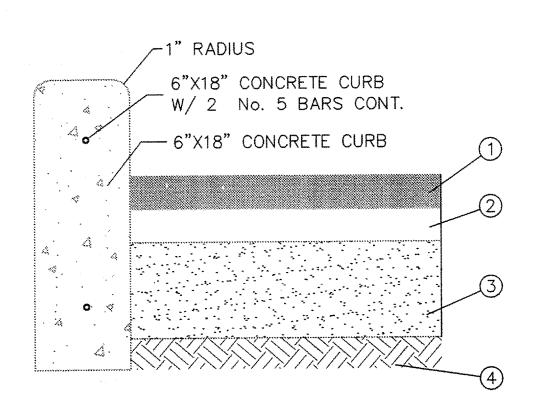

CURB/ASPHALT DETAIL

ODOT ITEM

DESCRIPTION


1 - 404 1-1/2" ASPHALT CONCRETE

2 - 402 2-1/2" ASPHALT CONCRETE

4 - 203 COMPACTED SUBGRADE

3 – 304 6" AGGREGATE BASE

NOTE: AGGREGATE BASE TO BE LIMESTONE ONLY, NO SLAG PERMITTED.

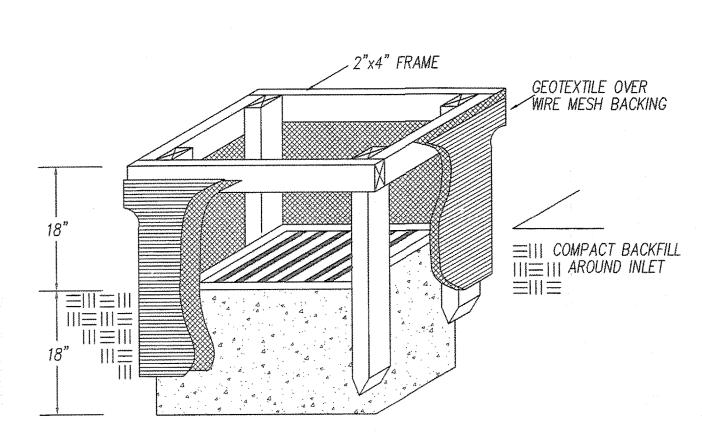

1. INLET PROTECTION SHALL BE CONSTRUCTED EITHER BEFORE UPSLOPE LAND DISTURBANCE OR BEFORE THE STORM DRAIN BECOMES OPERATIONAL.

2. THE EARTH AROUND THE INLET SHALL BE EXCAVATED COMPLETELY TO A DEPTH AT

3. THE WOODEN FRAME SHALL BE CONSTRUCTED OF 2 BY 4 IN. CONSTRUCTION-GRADE LUMBER. THE 2 BY 4 IN. POSTS SHALL BE DRIVEN 2 FT. INTO THE GROUND AT FOUR CORNERS OF THE INLET AND THE TOP PORTION OF THE 2 BY 4 IN. FRAMED PORTION OF 2 BY 4 IN. FRAME ASSEMBLED USING THE OVERLAP JOINT SHOWN. THE TOP OF THE FRAME SHALL BE AT LEAST 6 IN. BELOW ADJACENT ROADS IF PONDED WATER WOULD POSE A SAFETY HAZARD TO TRAFFIC.

4. WIRE MESH SHALL BE OF SUFFICIENT STRENGTH TO SUPPORT FABRIC WITH WATER FULLY IMPOUNDED AGAINST IT. IT SHALL BE STRETCHED TIGHTLY AROUND THE FRAME AND FASTENED SECURELY TO THE FRAME.


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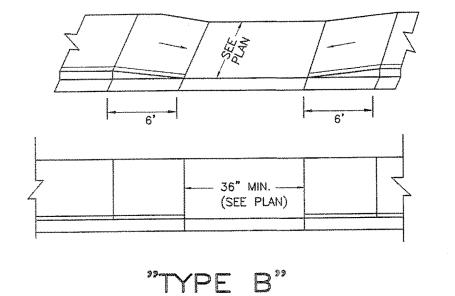
5. GEOTEXTILE SHALL HAVE AN EQUIVALENT OPENING SIZE OF 20-40 SIEVE AND BE RESILIENT TO SUNLIGHT. IT SHALL BE STRETCHED TIGHTLY AROUND THE FRAME AND FASTENED SECURELY. IT SHALL THE GEOTEXTILE SHALL OVERLAP ACROSS ONE SIDE OF THE INLET SO THE ENDS OF THE CLOTH ARE NOT FASTENED TO THE

6. BACKFILL SHALL BE PLACED AROUND THE INLET IN COMPACTED 6 IN. LAYERS UNTIL THE EARTH IS EVEN WITH NOTCH ELEVATION ON ENDS AND TOP ELEVATION ON SIDES.

7. A COMPACTED EARTH DIKE OR A CHECK DAM SHALL BE CONSTRUCTED IN THE DITCH LINE BELOW THE INLET IF THE INLET IS NOT IN A DEPRESSION AND IF RUNOFF BYPASSING THE INLET WILL NOT FLOW TO A SETTLING POND. THE TOP OF THE EARTH DIKES SHALL BE AT LEAST 6 IN. HIGHER THAN THE TOP OF THE FRAME.

INLET PROTECTION



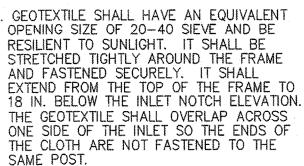

4' 6'

<u>PLAN</u>

ELEVATION

"TYPE A"

N.T.S.

HANDICAP RAMP DETAIL

NOTE: RAMP TO BE CONSTRUCTED W/ TRUNCATED

DOMES PER A.D.A. REQUIREMENTS.

6" REVEAL **TYPICAL**


HANDICAP RAMP DETAIL N.T.S. NOTE: RAMP TO BE CONSTRUCTED W/ TRUNCATED

DOMES PER A.D.A. REQUIREMENTS.

TEMPORARY BASIN OUTLET STRUCTURE TO REMAIN IN PLACE UNTIL ALL UPLAND AREAS HAVE BEEN PERMANENTLY SEEDED. SEDIMENTATION SHALL BE REMOVED FROM LAKES TO RESTORE LAKE BOTTOM TO DESIGN GRADES. STAND PIPE TO BE REINFORCED WITH TYPE 1 OR TYPE 2 ROCK, CATCH BASIN OR HEADWALL WATER SURFACE "WATERPLUG CONCRETE SEAL **TEMPORARY**


BASIN OUTLET

N.T.S.

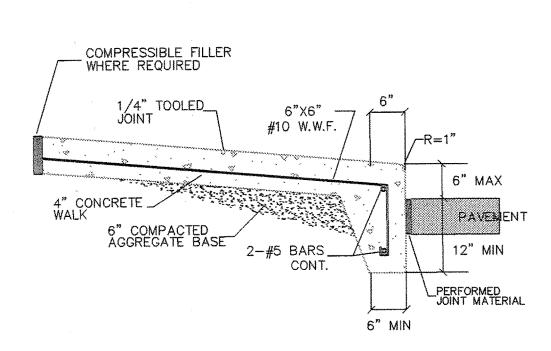


TBO

INTEGRAL CONCRETE WALK & CURB DETAIL

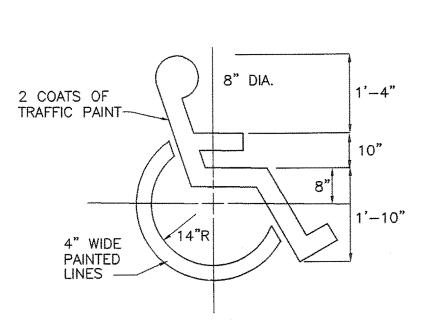


HANDICAP SYMBOL

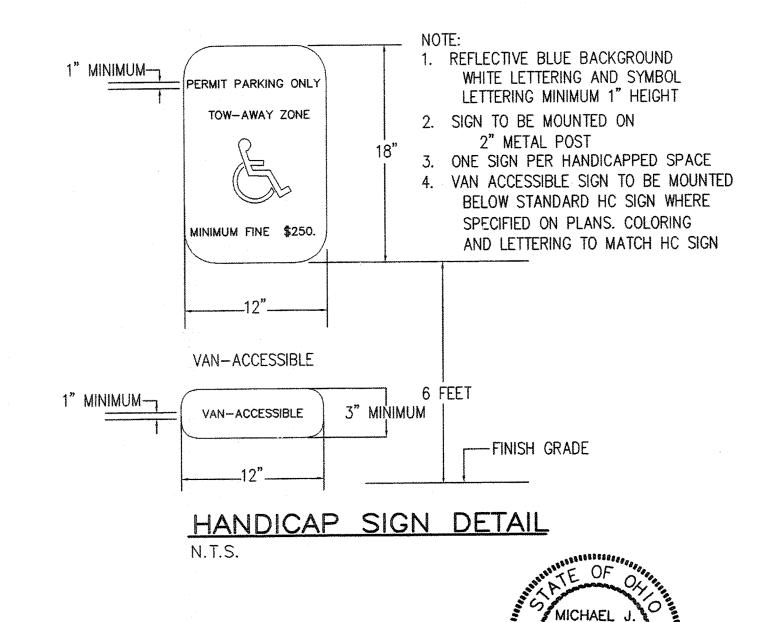

CONSTRUCTION DETAILS

EPIPHANY LUTHERAN CHURCH 10503 VALLEY VIEW ROAD NORTHFIELD CENTER TWP., OHIO

Date Revisions Date: 03-04-05 A. Pre-Final Submission <u>2-28-05</u> WLM Drawn By: 3-04-05 O. Plan Review-Bid Checked By: MJW Field Book: Scale: JOB NO.

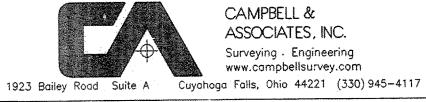


CAMPBELL & ASSOCIATES, INC. Surveying . Engineering www.campbellsurvey.com


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WOHLWEND

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ELEVATION

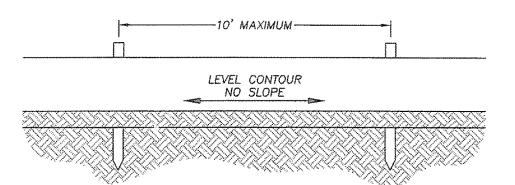


SPECIFICATIONS FOR SILT FENCE


- 1. SILT FENCE SHALL BE CONSTRUCTED BEFORE UPSLOPE LAND DISTURBANCE BEGINS.
- 2. ALL SILT FENCE SHALL BE PLACED AS CLOSE TO THE CONTOUR AS POSSIBLE SO THAT WATER WILL NOT CONCENTRATE AT LOW POINTS IN THE FENCE AND SO THAT SMALL SWALES OR DEPRESSIONS WHICH MAY CARRY SMALL CONCENTRATED FLOWS TO THE SILT FENCE ARE DISSIPATED ALONG ITS LENGTH.
- 3. TO PREVENT WATER PONDED BY THE SILT FENCE FROM FLOWING AROUND THE ENDS, EACH END SHALL BE CONSTRUCTED UPSLOPE SO THAT THE ENDS ARE AT A HIGHER ELEVATION.
- 4. WHERE POSSIBLE, SILT FENCE SHALL BE PLACED
- ON THE FLATTEST AREA AVAILABLE. 5. WHERE POSSIBLE, VEGETATION SHALL BE
- PRESERVED FOR 5 FT. (OR AS MUCH AS POSSIBLE) UPSLOPE FROM THE SILT FENCE, IF VEGETATION IS REMOVED, IT SHALL BE REESTABLISHED WITHIN 7 DAYS FROM THE INSTALLATION OF THE SILT FENCE.
- 6. THE HEIGHT OF THE SILT FENCE SHALL BE A MINIMUM OF 16 IN. ABOVE THE ORIGINAL GROUND SURFACE.
- 7. THE SILT FENCE SHALL BE PLACED IN A TRENCH CUT A MINIMUM OF 6 IN. DEEP, THE TRENCH SHALL BE CUT WITH A TRENCHER, CABLE LAYING MACHINE, OR OTHER SUITABLE DEVICE WHICH WILL ENSURE AN ADEQUATELY UNIFORM TRENCH DEPTH.

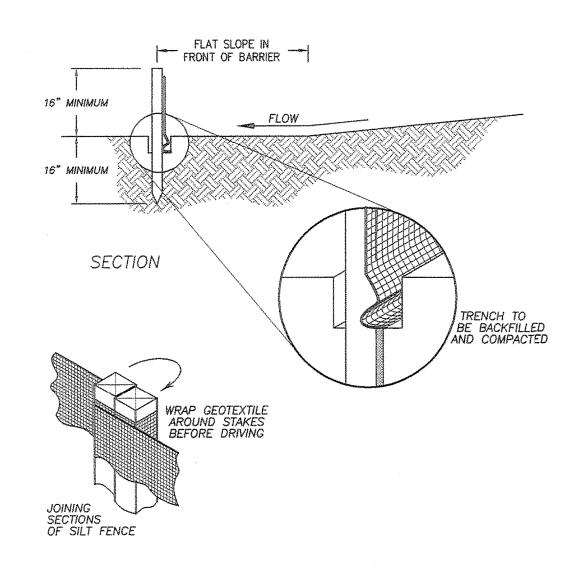- 8. THE SILT FENCE SHALL BE PLACED WITH THE STAKES ON THE DOWNSLOPE SIDE OF THE GEOTEXTILE AND SO THAT 8 IN. OF CLOTH ARE BELOW THE GROUND SURFACE. EXCESS MATERIAL SHALL LAY ON THE BOTTOM OF THE 6 IN. DEEP TRENCH. THE TRENCH SHAL BE BACKFILLED AND COMPACTED.
- 9. SEAMS BETWEEN SECTION OF SILT FENCE SHALL BE OVERLAPPED WITH THE END STAKES OF EACH SECTION WRAPPED TOGETHER BEFORE DRIVING INTO THE GROUND.
- 10. MAINTENANCE -- SILT FENCE SHALL ALLOW RUNOFF TO PASS ONLY AS DIFFUSE FLOW THROUGH THE GEOTEXTILE. IF RUNOFF OVERTOPS THE SILT FENCE, FLOWS UNDER OR AROUND THE ENDS, OR IN ANY OTHER WAY BECOMES A CONCENTRATED FLOW, ONE OF THE FOLLOWING SHALL BE PERFORMED, AS APPROPRIATE: 1) THE LAYOUT OF THE SILT FENCE SHALL BE CHANGED, 2) ACCUMULATED SEDIMENT SHALL BE REMOVED, OR 3) OTHER PRACTICES SHALL BE INSTALLED.
- CRITERIA FOR SILT FENCE MATERIALS
- 1. FENCE POSTS--THE LENGTH SHALL BE A MINIMUM OF 32 IN. LONG, WOOD POSTS WILL BE 2-BY-2 IN. HARDWOOD OF SOUND QUALITY. THE MAXIMUM SPACING BETWEEN POSTS SHALL BE 10 FT.
- 2. SILT FENCE FABRIC (SEE CHART BELOW):


FABRIC PROPERTIES	VALUES	TEST METHOD
GRAB TENSILE STRENGTH	90 LB. MINIMUM	ASTM D 1682
MULLEN BURST STRENGTH	190 PSI MINIMUM	ASTM D 3786
SLURRY FLOW RATE	0.3 GAL./MIN./F2 MAXIMUM	
EQUIVALENT OPENING SIZE	40-80	US STD. SIEVE CW-02215
ULTRAVIOLET RADIATION STABILITY	90% MINIMUM	ASTM-G-26

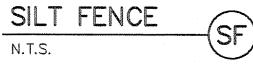

STANDARD DRAWINGS	DATE
ODOT 2-3 CB	7/12/95
ODOT MH-3	12/18/84
and the same of th	

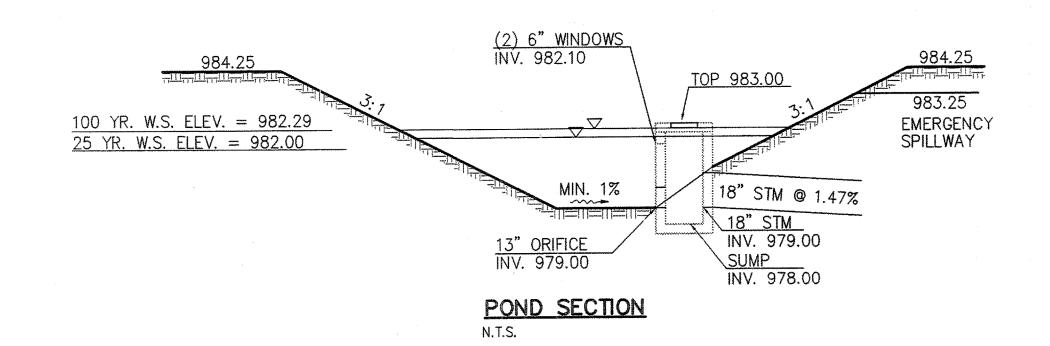

GRANULAR BACKFILL TO BE USED ON ALL SEWER EXCAVATIONS IN SIDEWALKS, DRIVE APPROACHES, AND STREETS. ALL CONDUIT SHALL BE INSTALLED ON A FIRM BED FOR ITS FULL LENGTH IN ACCORDANCE WITH ODOT ITEM 603.03. BEDDING AND BACKFILL FOR SANITARY SEWERS SHALL BE IN ACCORDANCE WITH STM D-2321.

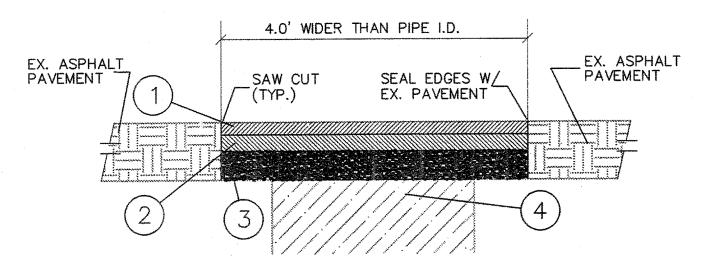

PAVEMENT REPLACEMENT DETAIL

DESCRIPTION ODOT ITEM


1 - 404 1-1/4" ASPHALT CONCRETE

2 - 402 1-3/4" ASPHALT CONCRETE


3 - 304 6" AGGREGATE BASE

4 - COMPACTED BACKFILL


1923 Bailey Road Suite A Cuyahoga Falls, Ohio 44221 (330) 945-4117

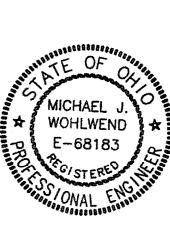


SHEET: C-6

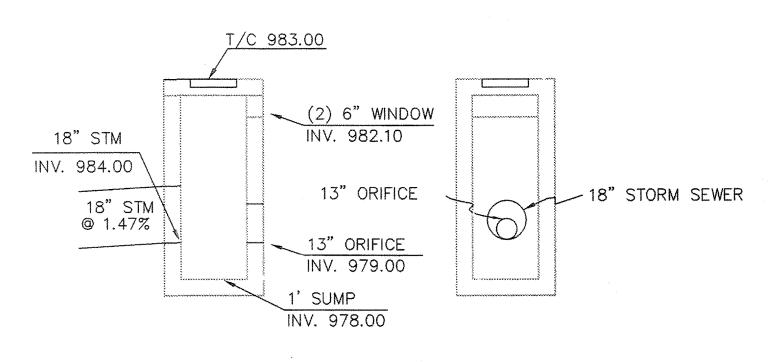

POND OUTLET STRUCTURE DETAIL (ODOT 2-3 CATCH BASIN MODIFIED) NOT TO SCALE

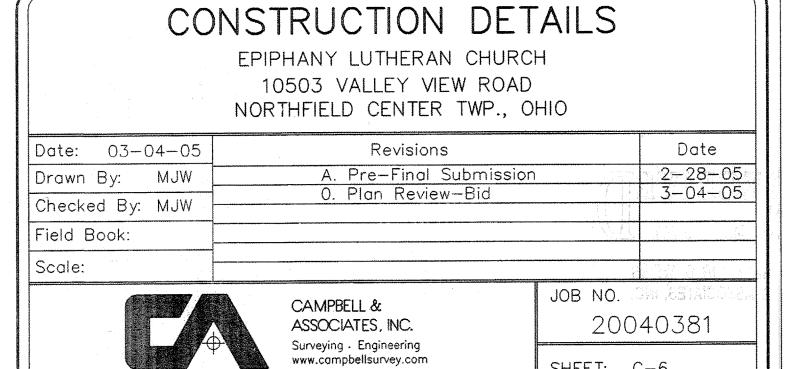

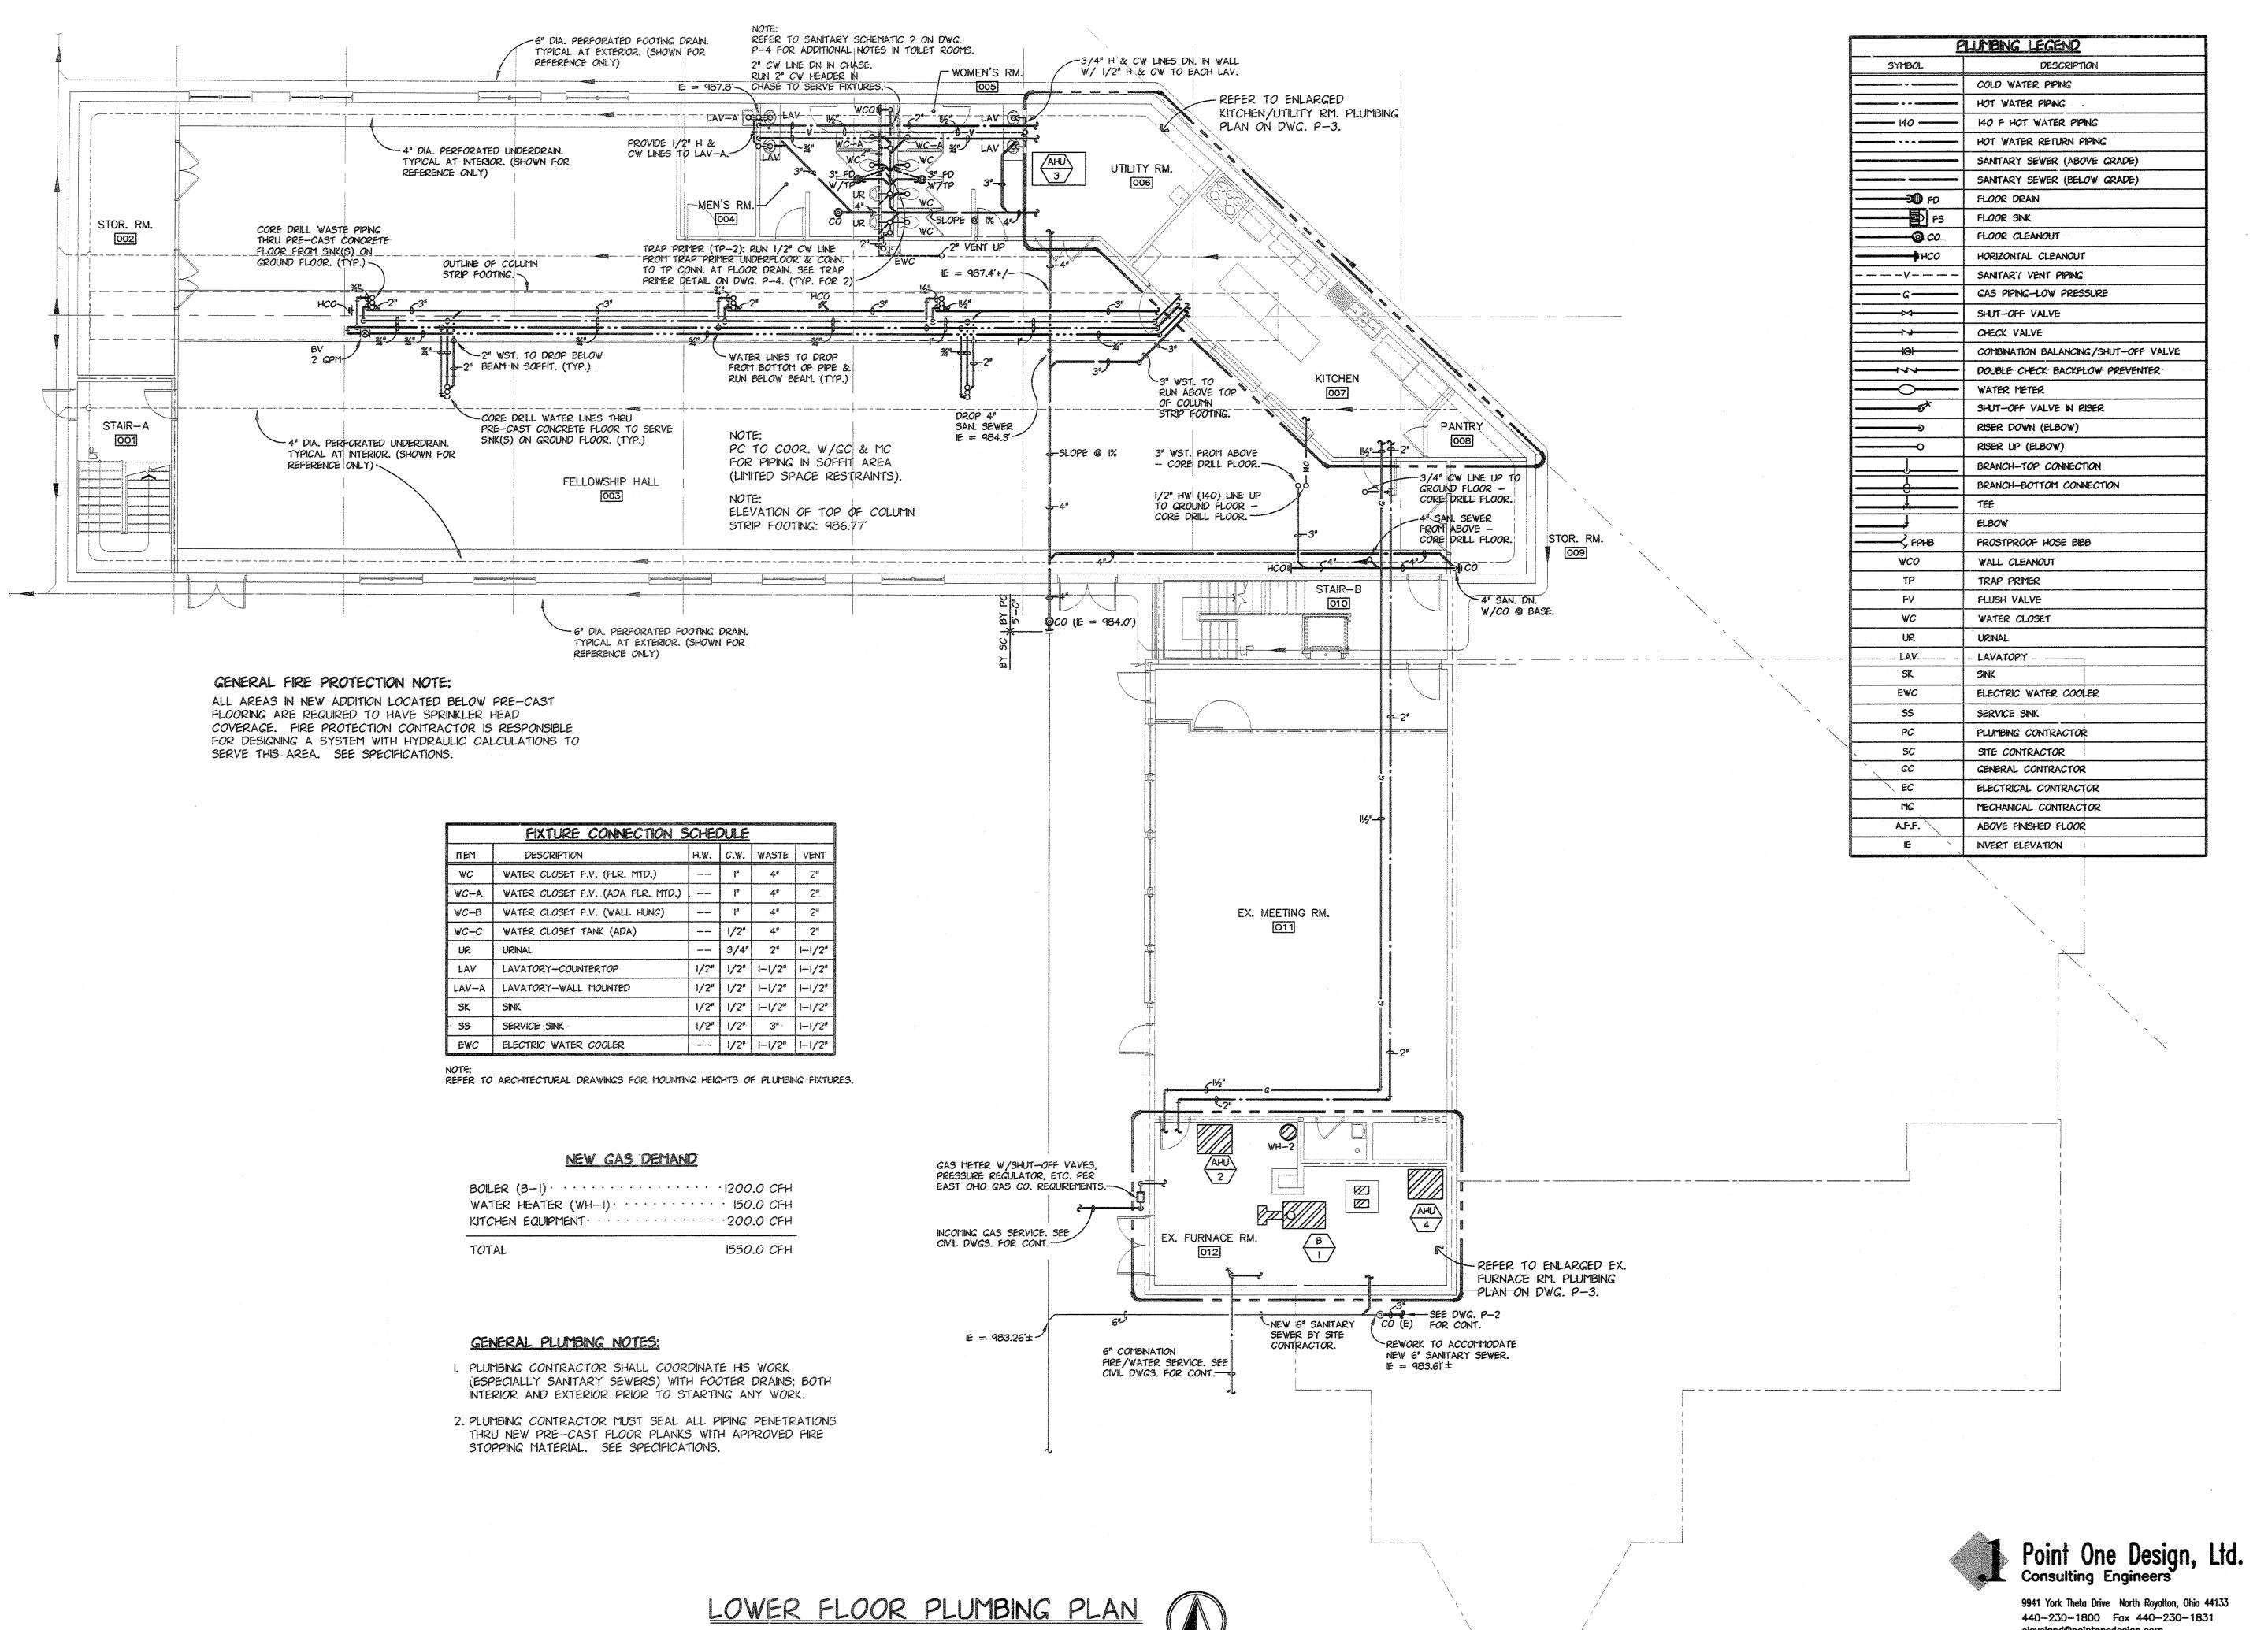

SCALE: 1/8" = 1'-0"

FINISH FLOOR ELEVATION = 988.6'

KEVIN

HERBERT

E-53288

REVISIONS:


0413-ELC 03-04-05. . NLP. SCALE: 1/8" - 1'-0".

SHEET NO.

cleveland@pointonedesign.com 933 High Street, Suite 106 Worthington, Ohio 43085 614-540-3500 Fax 614-540-3502

columbus@pointonedesign.com

440-230-1800 Fax 440-230-1831

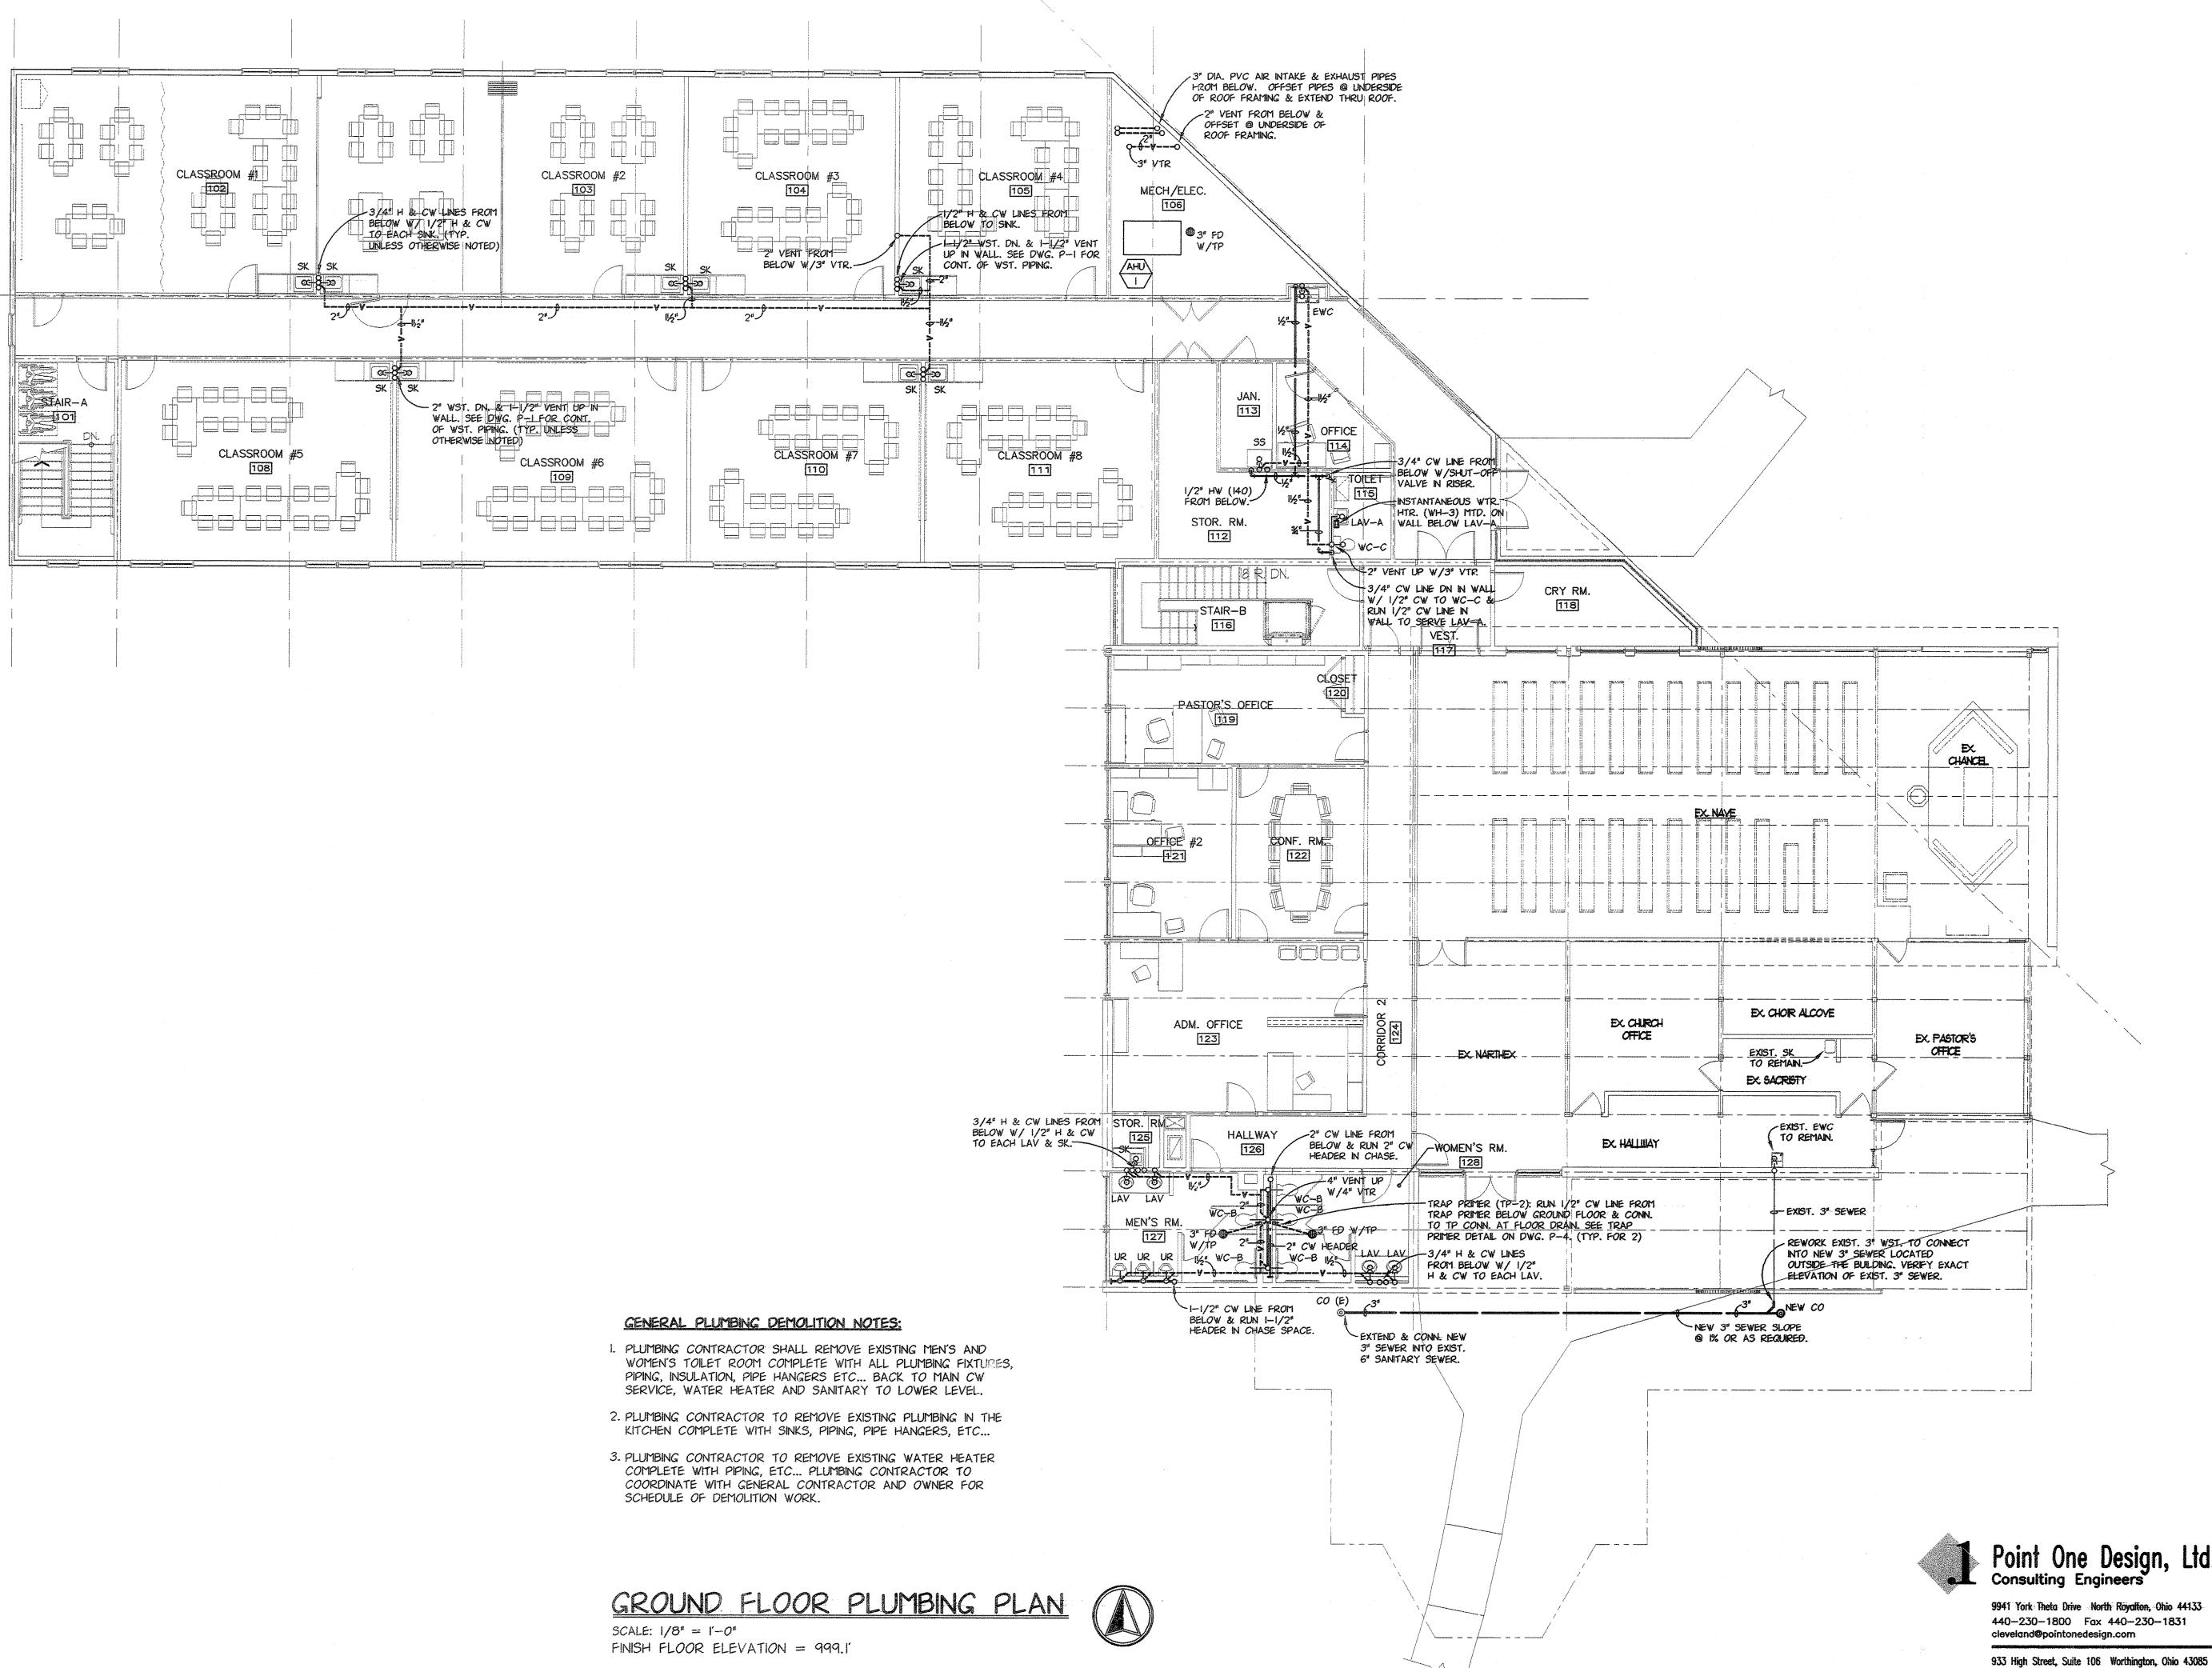

KEVIN

KE

DATE REMARKS

O2-28-05 PRE-FINAL SLBMISSION

O5-04-05 PLAN REVIEW/ BIP

SSOON STANKEN SIPP

ISSUED STANKEN SIPP

I

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Space Planning Facility Manag

PHILIP · F · PAULIN Architecture Space Planning

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SO VALEY VIEW ROAD
SO VALEY VIEW

ADDITIONS & AL
EPIPHANY LUTHER


PROJECT NUMBER:
0413-ELC


DATE: DRAWN BY:
03-04-05...MJ.P...


9CALE: CHECKED BY:
1/8" = 1'-0"...KKH...


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933 High Street, Suite 106 Worthington, Ohio 43085
614-540-3500 Fax 614-540-3502
columbus@pointonedesign.com




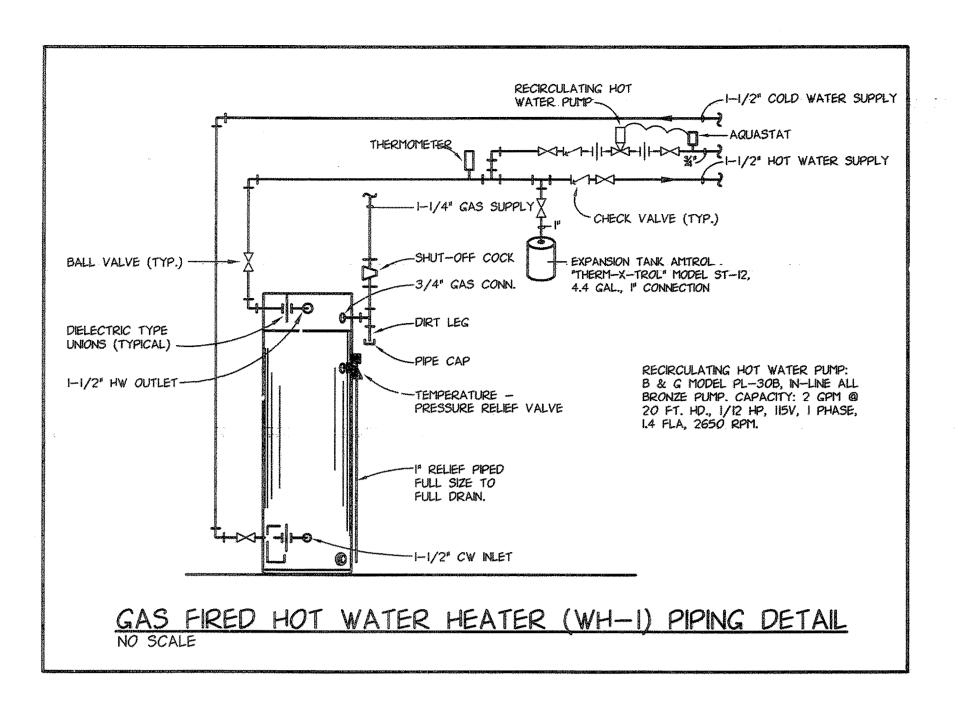

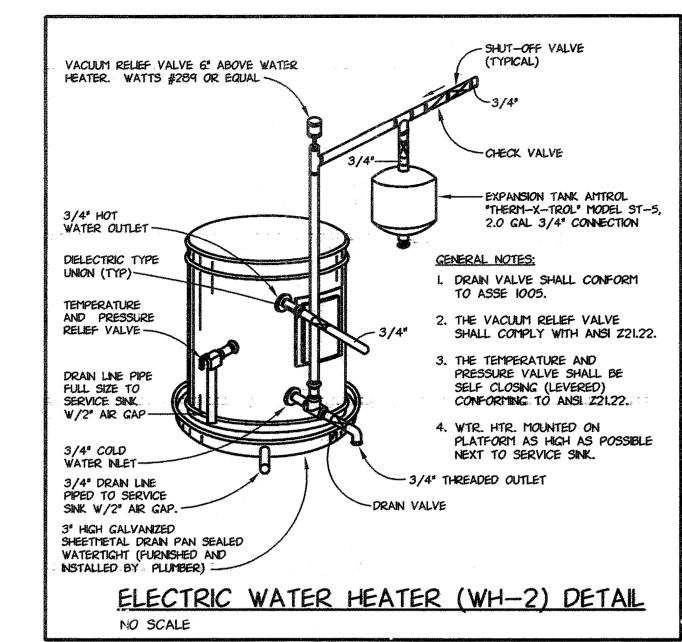

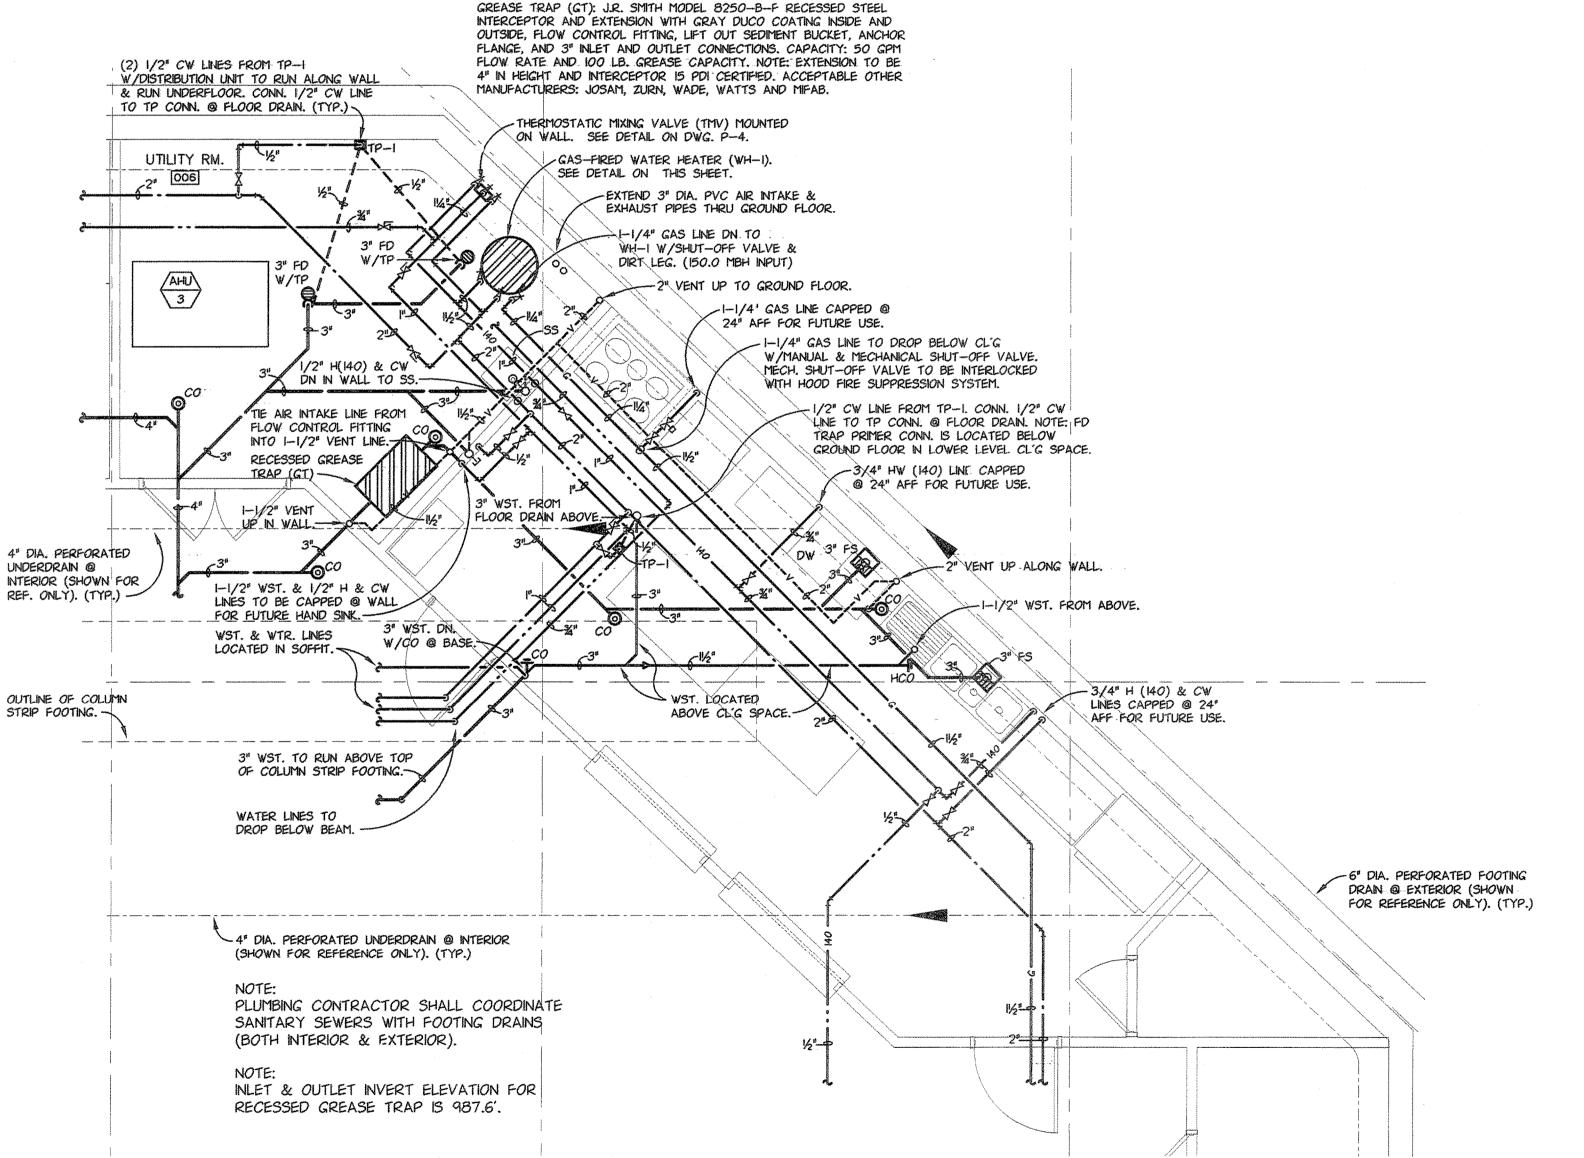

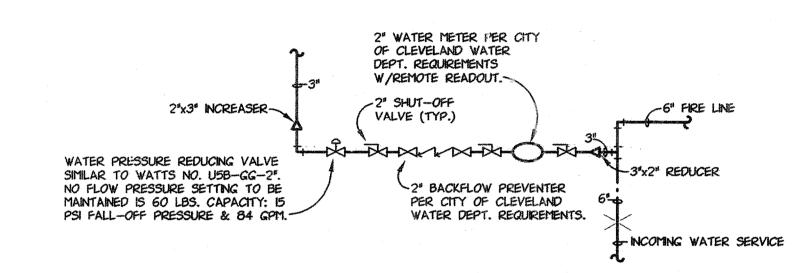DOMESTIC WATER SERVICE DIAGRAM NO SCALE

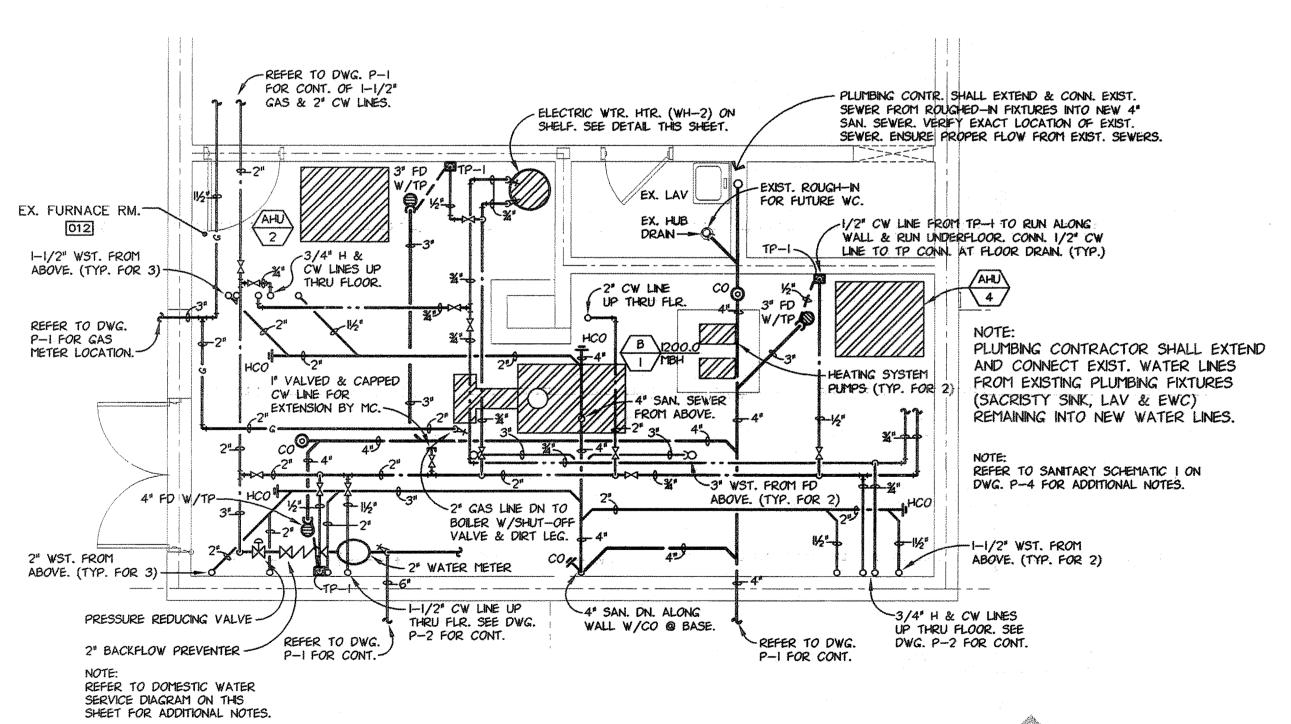

ENLARGED EX. FURNACE RM. PLUMBING PLAN SCALE: 1/4" = 1'-0"



Consulting Engineers

440-230-1800 Fox 440-230-1831

614-540-3500 Fax 614-540-3502 columbus@pointonedesign.com

ENLARGED KITCHEN/UTILITY RM. PLUMBING PLAN SCALE: 1/4" = 1-0"



cleveland@pointonedesign.com 933 High Street, Suite 106 Worthington, Ohio 43085 REVISIONS:

KEVIN

HERBERT

E-53288

PHArchit

DETAILS

PLUMBING


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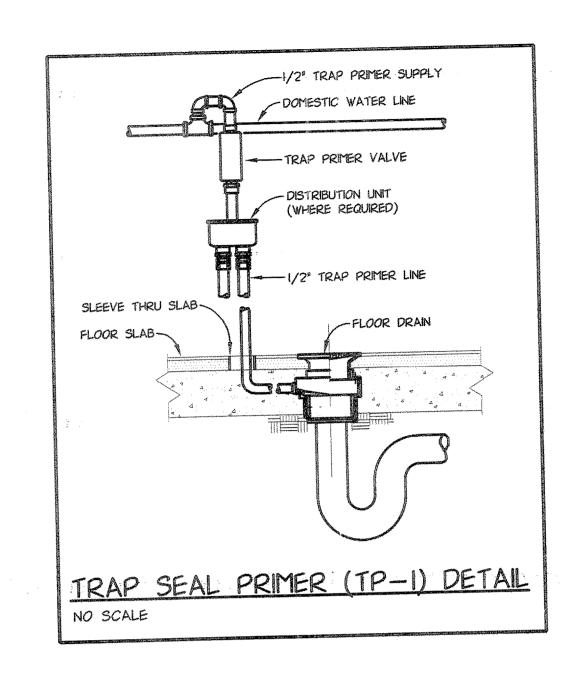
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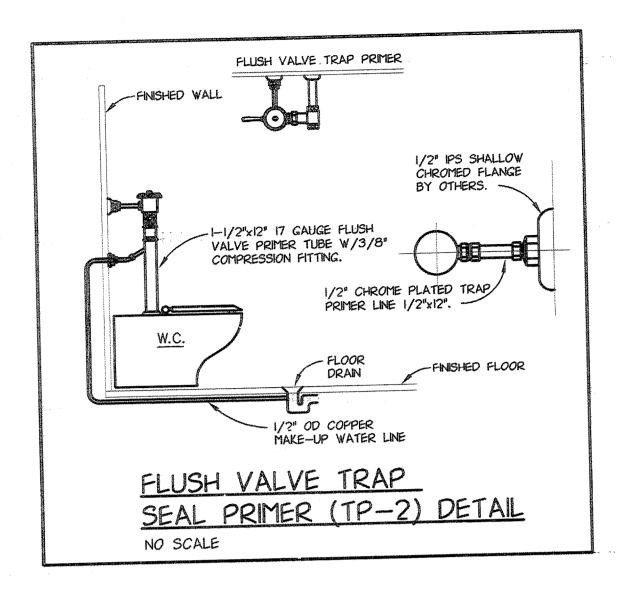
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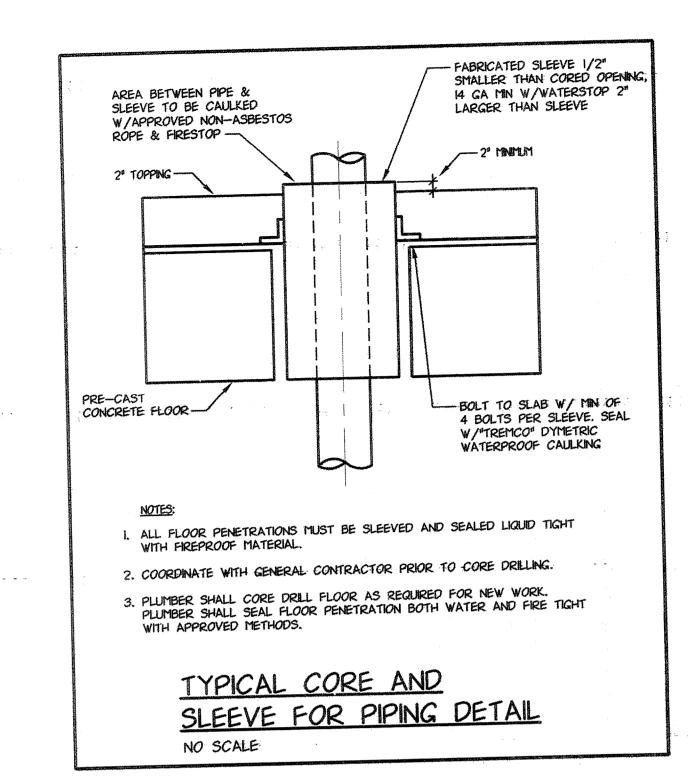
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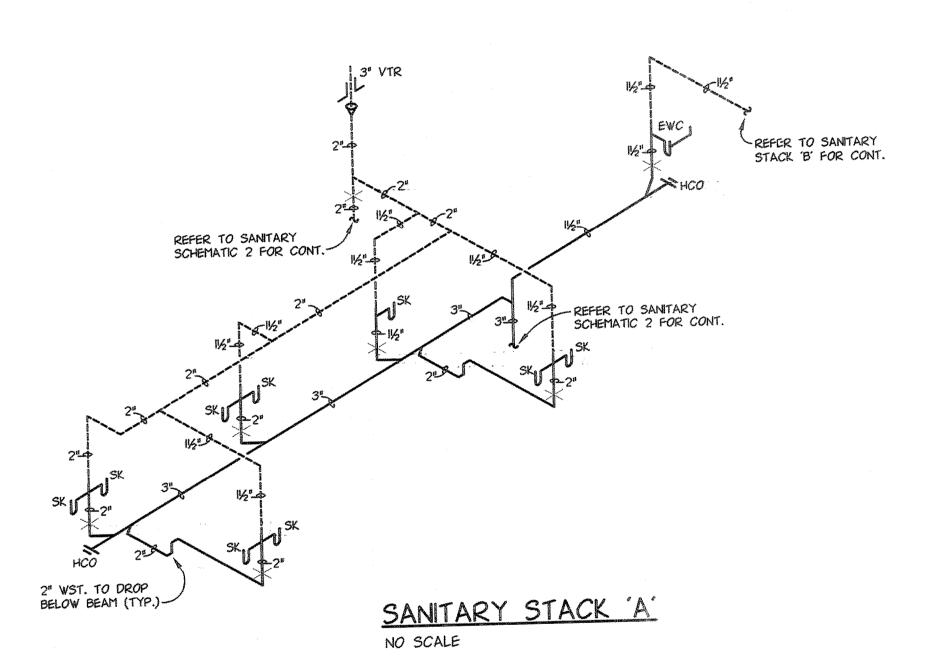
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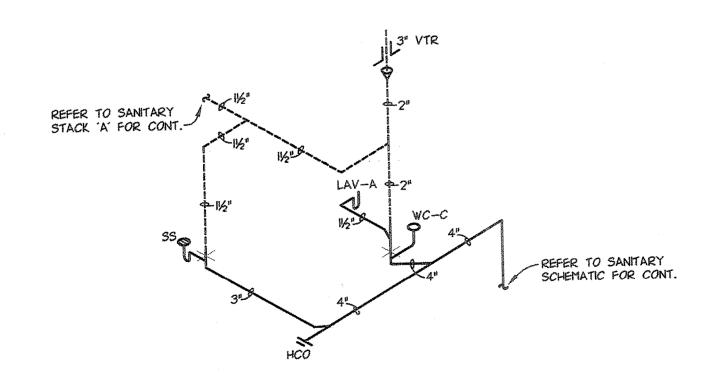











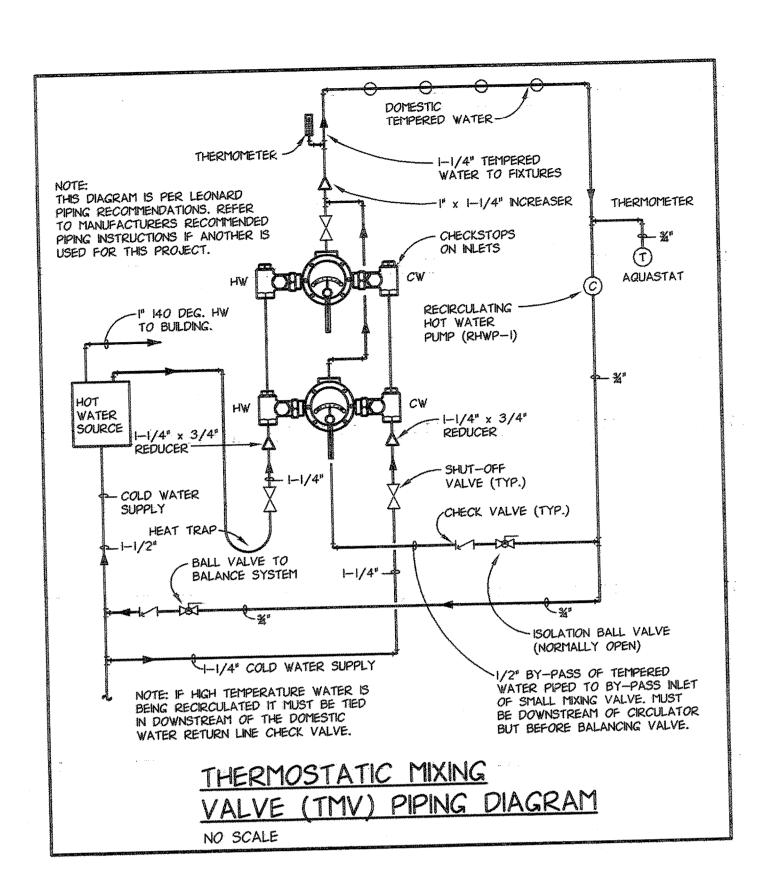

SANITARY STACK B' NO SCALE

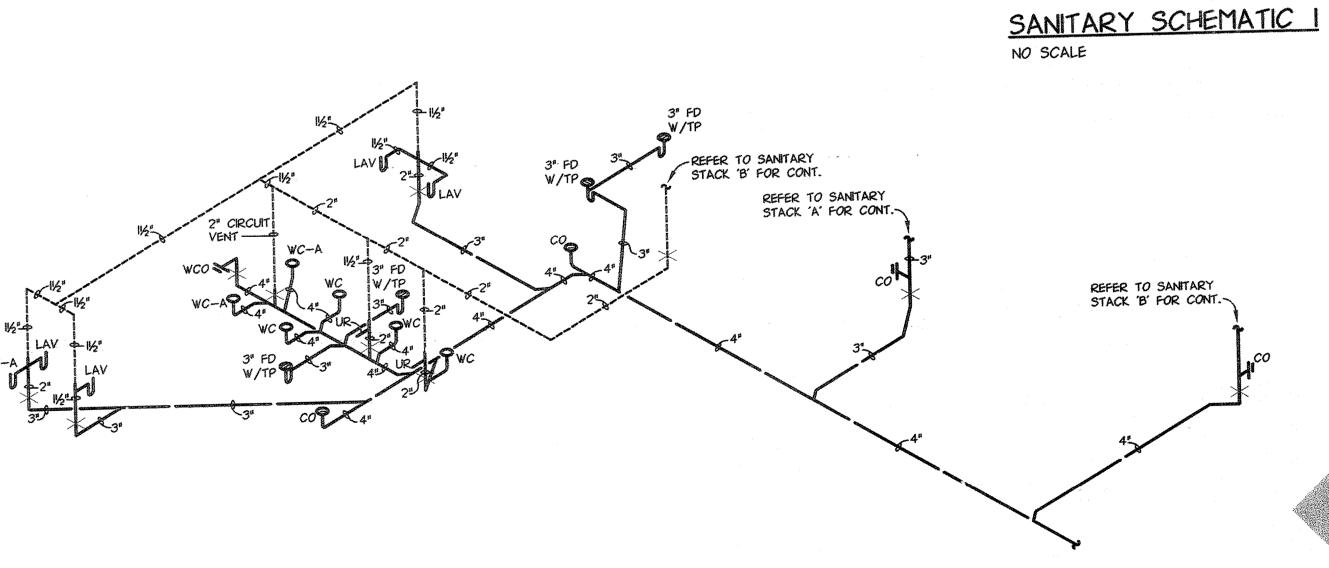

SANITARY SCHEMATIC 2

NO SCALE



Point One Design, Ltd.
Consulting Engineers

9941 York Theta Drive North Royalton, Ohio 44133 440-230-1800 Fax 440-230-1831 cleveland@pointonedesign.com

933 High Street, Suite 106 Worthington, Ohio 43085 614-540-3500 Fax 614-540-3502 columbus@pointonedesign.com

KEVIN HERBERT E-53288

REVISIONS:

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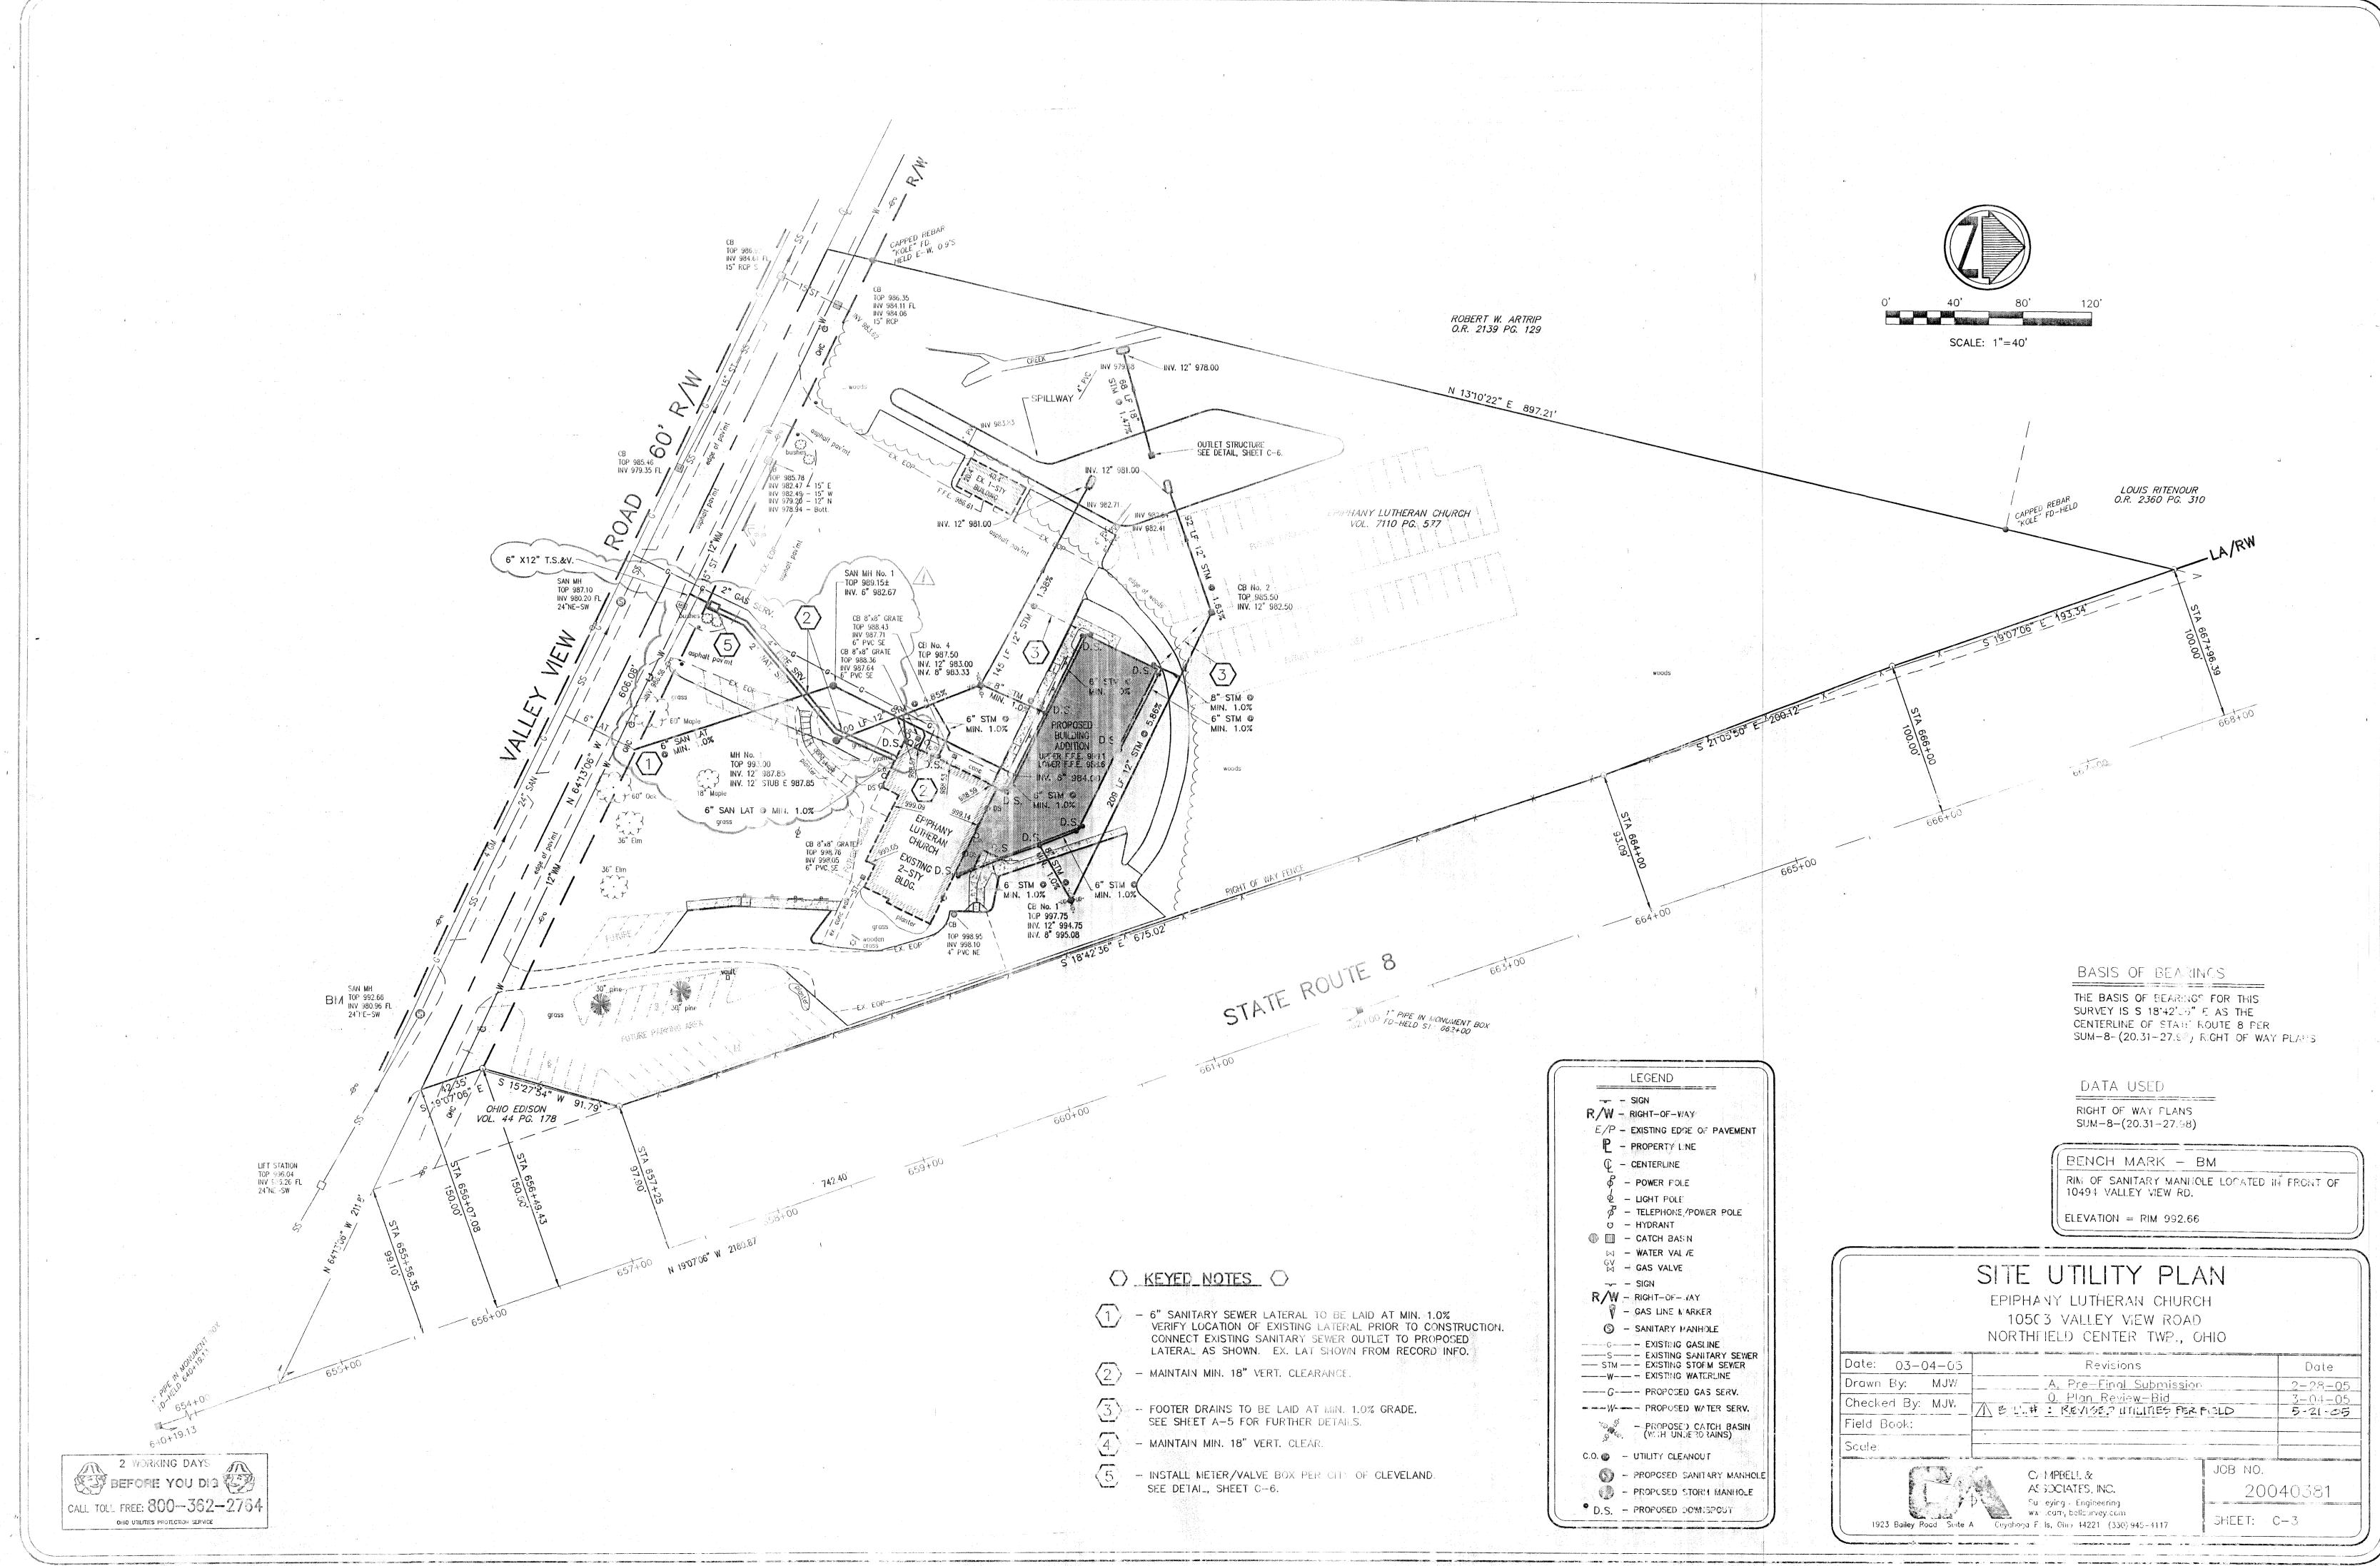
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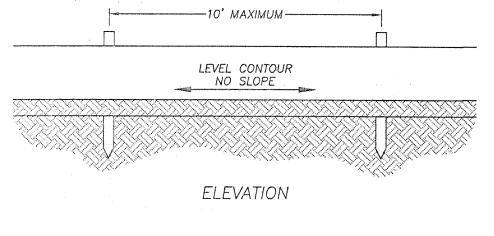
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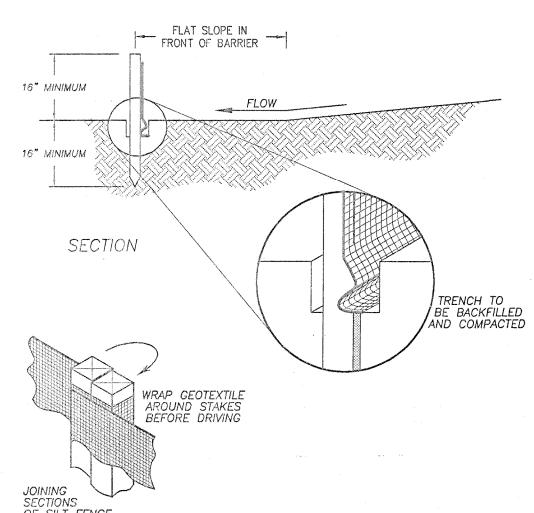
ADDITIONS EPIPHANY LI

PROJECT NUMBERS Q3-Q4-Q5. SCALE:

NO SCALE. SHEET NO.: CD







SPECIFICATIONS FOR SILT FENCE

- 1. SILT FENCE SHALL BE CONSTRUCTED BEFORE UPSLOPE LAND DISTURBANCE BEGINS.
- 2. ALL SILT FENCE SHALL BE PLACED AS CLOSE TO THE CONTOUR AS POSSIBLE SO THAT WATER WILL NOT CONCENTRATE AT LOW POINTS IN THE FENCE AND SO THAT SMALL SWALES OR DEPRESSIONS WHICH MAY CARRY SMALL CONCENTRATED FLOWS TO THE
- SILT FENCE ARE DISSIPATED ALONG ITS LENGTH. 3. TO PREVENT WATER PONDED BY THE SILT FENCE FROM FLOWING AROUND THE ENDS, EACH END SHALL BE CONSTRUCTED UPSLOPE SO THAT THE ENDS ARE AT A HIGHER ELEVATION.
- 4. WHERE POSSIBLE, SILT FENCE SHALL BE PLACED ON THE FLATTEST AREA AVAILABLE.
- 5. WHERE POSSIBLE, VEGETATION SHALL BE PRESERVED FOR 5 FT. (OR AS MUCH AS POSSIBLE) UPSLOPE FROM THE SILT FENCE. IF VEGETATION IS REMOVED, IT SHALL BE REESTABLISHED WITHIN 7 DAYS FROM THE INSTALLATION OF THE SILT FENCE.
- 6. THE HEIGHT OF THE SILT FENCE SHALL BE A MINIMUM OF 16 IN. ABOVE THE ORIGINAL GROUND SURFACE.
- 7. THE SILT FENCE SHALL BE PLACED IN A TRENCH CUT A MINIMUM OF 6 IN. DEEP. THE TRENCH SHALL BE CUT WITH A TRENCHER, CABLE LAYING MACHINE, OR OTHER SUITABLE DEVICE WHICH WILL ENSURE AN ADEQUATELY UNIFORM TRENCH DEPTH.


- 8. THE SILT FENCE SHALL BE PLACED WITH THE STAKES ON THE DOWNSLOPE SIDE OF THE GEOTEXTILE AND SO THAT 8 IN. OF CLOTH ARE BELOW THE GROUND SURFACE. EXCESS MATERIAL SHALL LAY ON THE BOTTOM OF THE 6 IN. DEEP TRENCH. THE TRENCH SHAL BE BACKFILLED AND COMPACTED.
- 9. SEAMS BETWEEN SECTION OF SILT FENCE SHALL BE OVERLAPPED WITH THE END STAKES OF EACH SECTION WRAPPED TOGETHER BEFORE DRIVING INTO THE GROUND.
- 10. MAINTENANCE--SILT FENCE SHALL ALLOW RUNOFF TO PASS ONLY AS DIFFUSE FLOW THROUGH THE GEOTEXTILE. IF RUNOFF OVERTOPS THE SILT FENCE, FLOWS UNDER OR AROUND THE ENDS, OR IN ANY OTHER WAY BECOMES A CONCENTRATED FLOW, ONE OF THE FOLLOWING SHALL BE PERFORMED, AS APPROPRIATE: 1) THE LAYOUT OF THE SILT FENCE SHALL BE CHANGED, 2) ACCUMULATED SEDIMENT SHALL BE REMOVED, OR 3) OTHER PRACTICES SHALL BE INSTALLED.
- CRITERIA FOR SILT FENCE MATERIALS


DATE <u>9-14-1998</u>

CHECKED BY MJS DATE 9-14-98


- 1. FENCE POSTS--THE LENGTH SHALL BE A MINIMUM OF 32 IN. LONG. WOOD POSTS WILL BE 2-BY-2 IN. HARDWOOD OF SOUND QUALITY. THE MAXIMUM SPACING BETWEEN POSTS SHALL BE 10 FT.
- 2. SILT FENCE FABRIC (SEE CHART BELOW):

FABRIC PROPERTIES	VALUES	TEST METHOD
GRAB TENSILE STRENGTH	90 LB. MINIMUM	ASTM D 1682
MULLEN BURST STRENGTH	190 PSI MINIMUM	ASTM D 3786
SLURRY FLOW RATE	0.3 GAL./MIN./F2 MAXIMUM	
EQUIVALENT OPENING SIZE	40-80	US STD. SIEVE CW-02215
ULTRAVIOLET RADIATION STABILITY	90% MINIMUM	ASTM-G-26

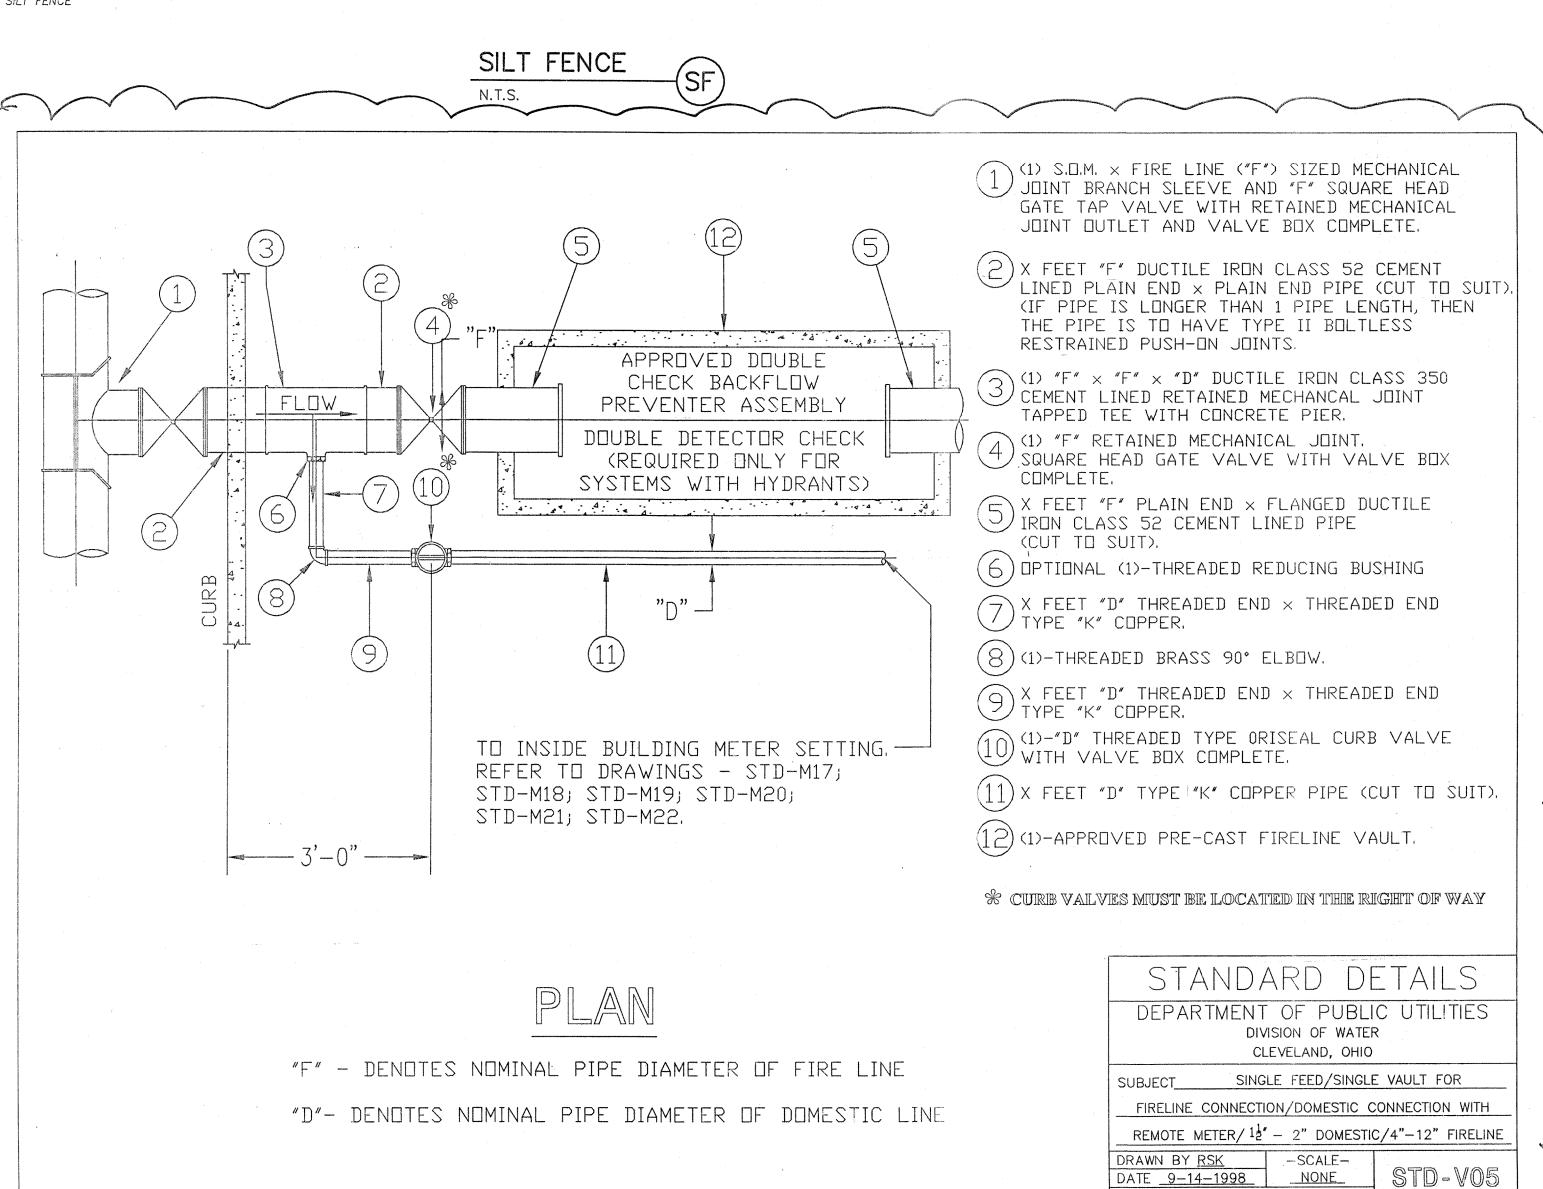

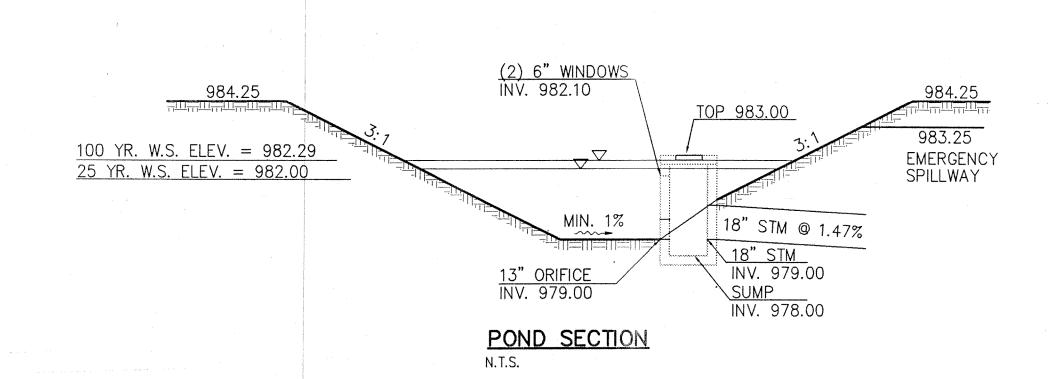

GRANULAR BACKFILL TO BE USED ON ALL SEWER EXCAVATIONS IN SIDEWALKS, DRIVE APPROACHES, AND STREETS. ALL CONDUIT SHALL BE INSTALLED ON A FIRM BED FOR ITS FULL LENGTH IN ACCORDANCE WITH ODOT ITEM 603.03. BEDDING AND BACKFILL FOR SANITARY SEWERS SHALL BE IN ACCORDANCE WITH STM D-2321

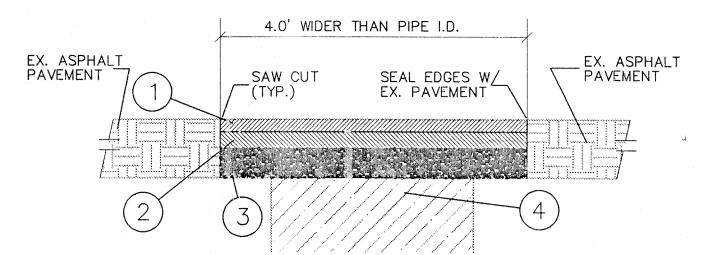


PAVEMENT REPLACEMENT DETAIL

DESCRIPTION

ODOT ITEM

- 1 404 1-1/4" ASPHALT CONCRETE
- $2 402 \quad 1 3/4$ " ASPHALT CONCRETE
- 3 304 6" AGGREGATE BASE
- 4 COMPACTED BACKFILL

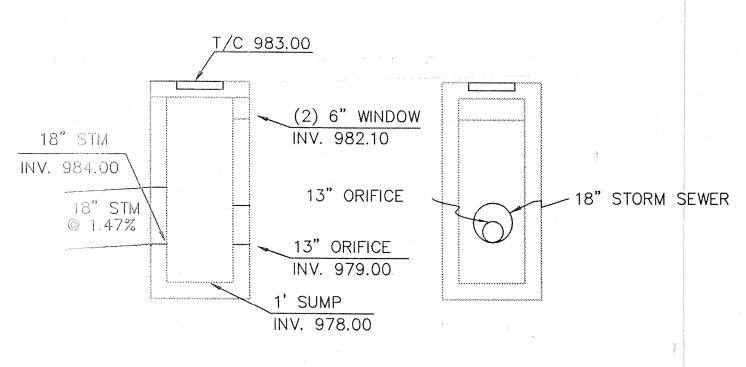

POND OUTLET STRUCTURE DETAIL (ODOT 2-3 CATCH BASIN MODIFIED) NOT TO SCALE

CONSTRUCTION DETAILS

EPIPHANY LUTHERAN CHURCH 10503 VALLEY VIEW ROAD NORTHFIELD CENTER TWP., OHIO

Date: 03-04-05	Revisions	Date
Drawn By: MJW	A. Pre-Final Submission	2-28-05
Checked By: MJW	0. Plan Review-Bid BULL、#1 / WATER SERVICE VAULT	3-04-05 5-21-05
Field Book:	DISCLAL VIV MAIN SPINGTON AND IT	9-21 0-0
Scale:		***************************************



ASSOCIATES, INC. Surveying . Engineering


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STANDARD DRAWINGS DATE

ODOT MH-3

7/12/95

12/18/84

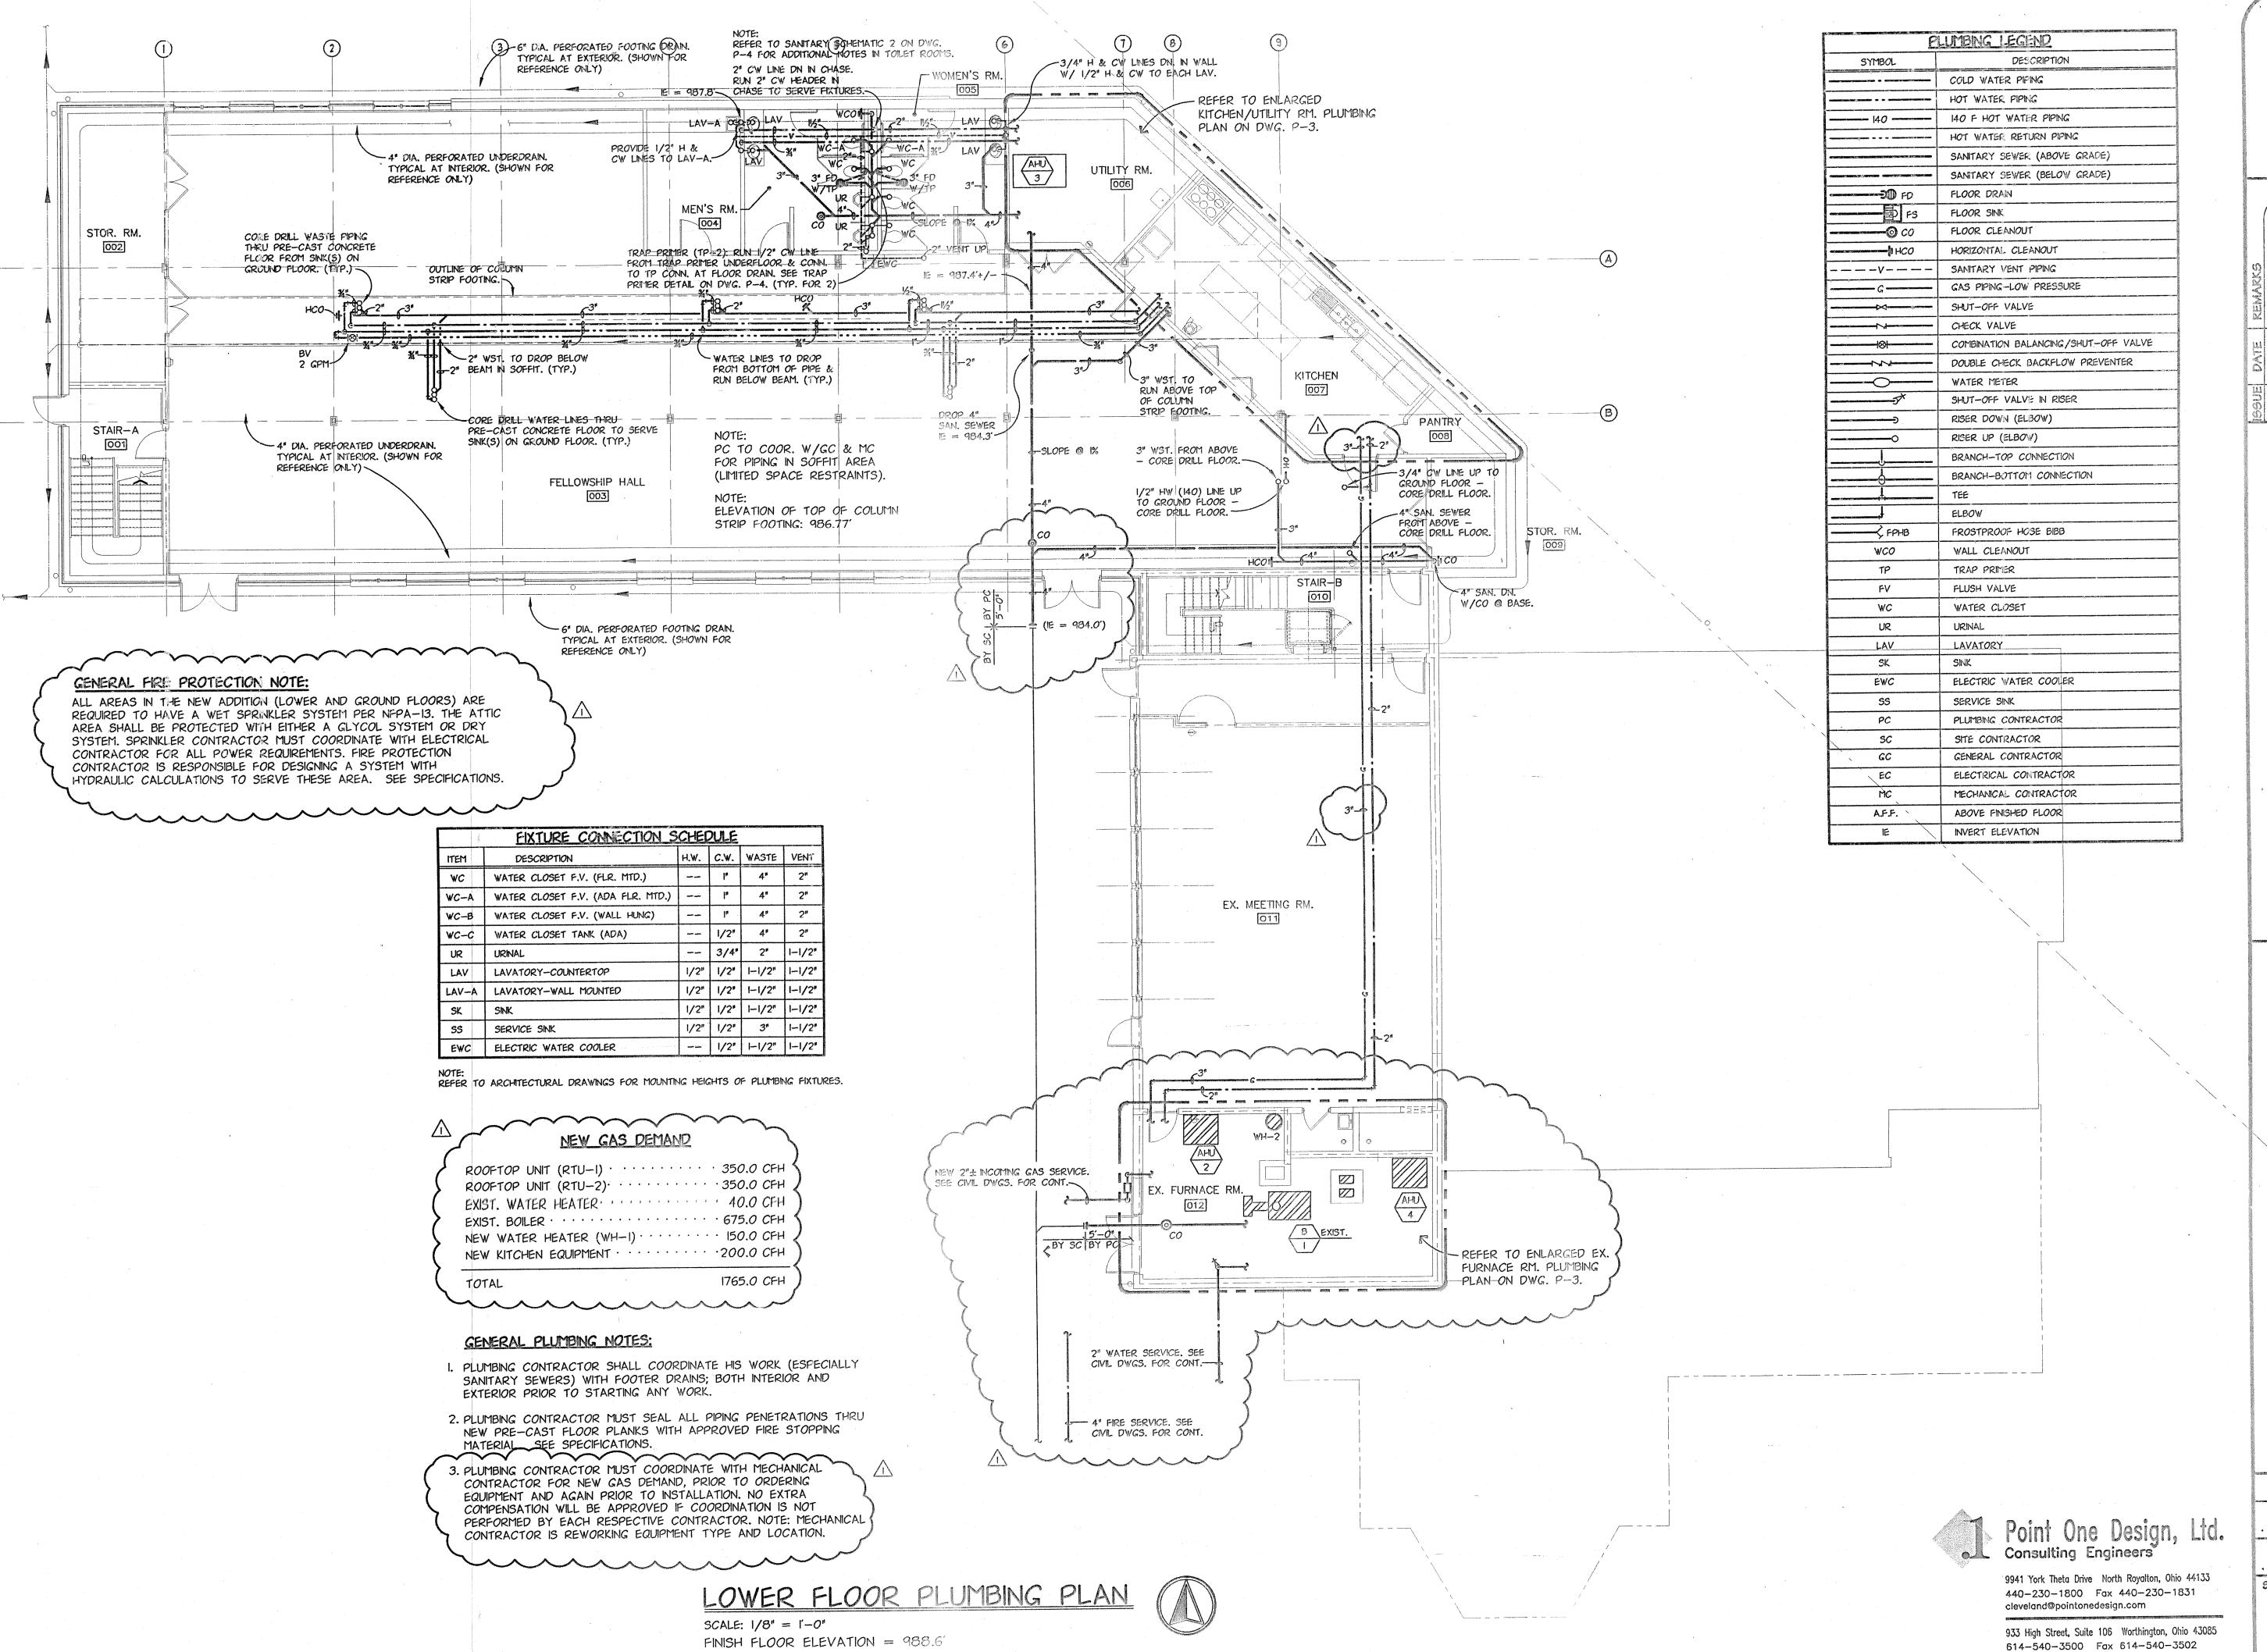

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E REMARKS

OF PRE-FINAL SLBMISSION

OS PLAN REVIEW/ BIP

OS BLLL, #1 - CONSTR, ISSLE

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Management | 05-10-05

Space Planning Facility Mana

C. T. T. T. T.

PANY CONTRACTOR OF THE AND WICHTER THE WICHOLD CENTER TWO CHICAGO WILLEY VIEW ROAD

PRAJECT NUMBER:
O413-ELC

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PROJECT NUMBER:

O413-ELC

DATE: DRAWN BY:

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SCALE: GHECKED BY:


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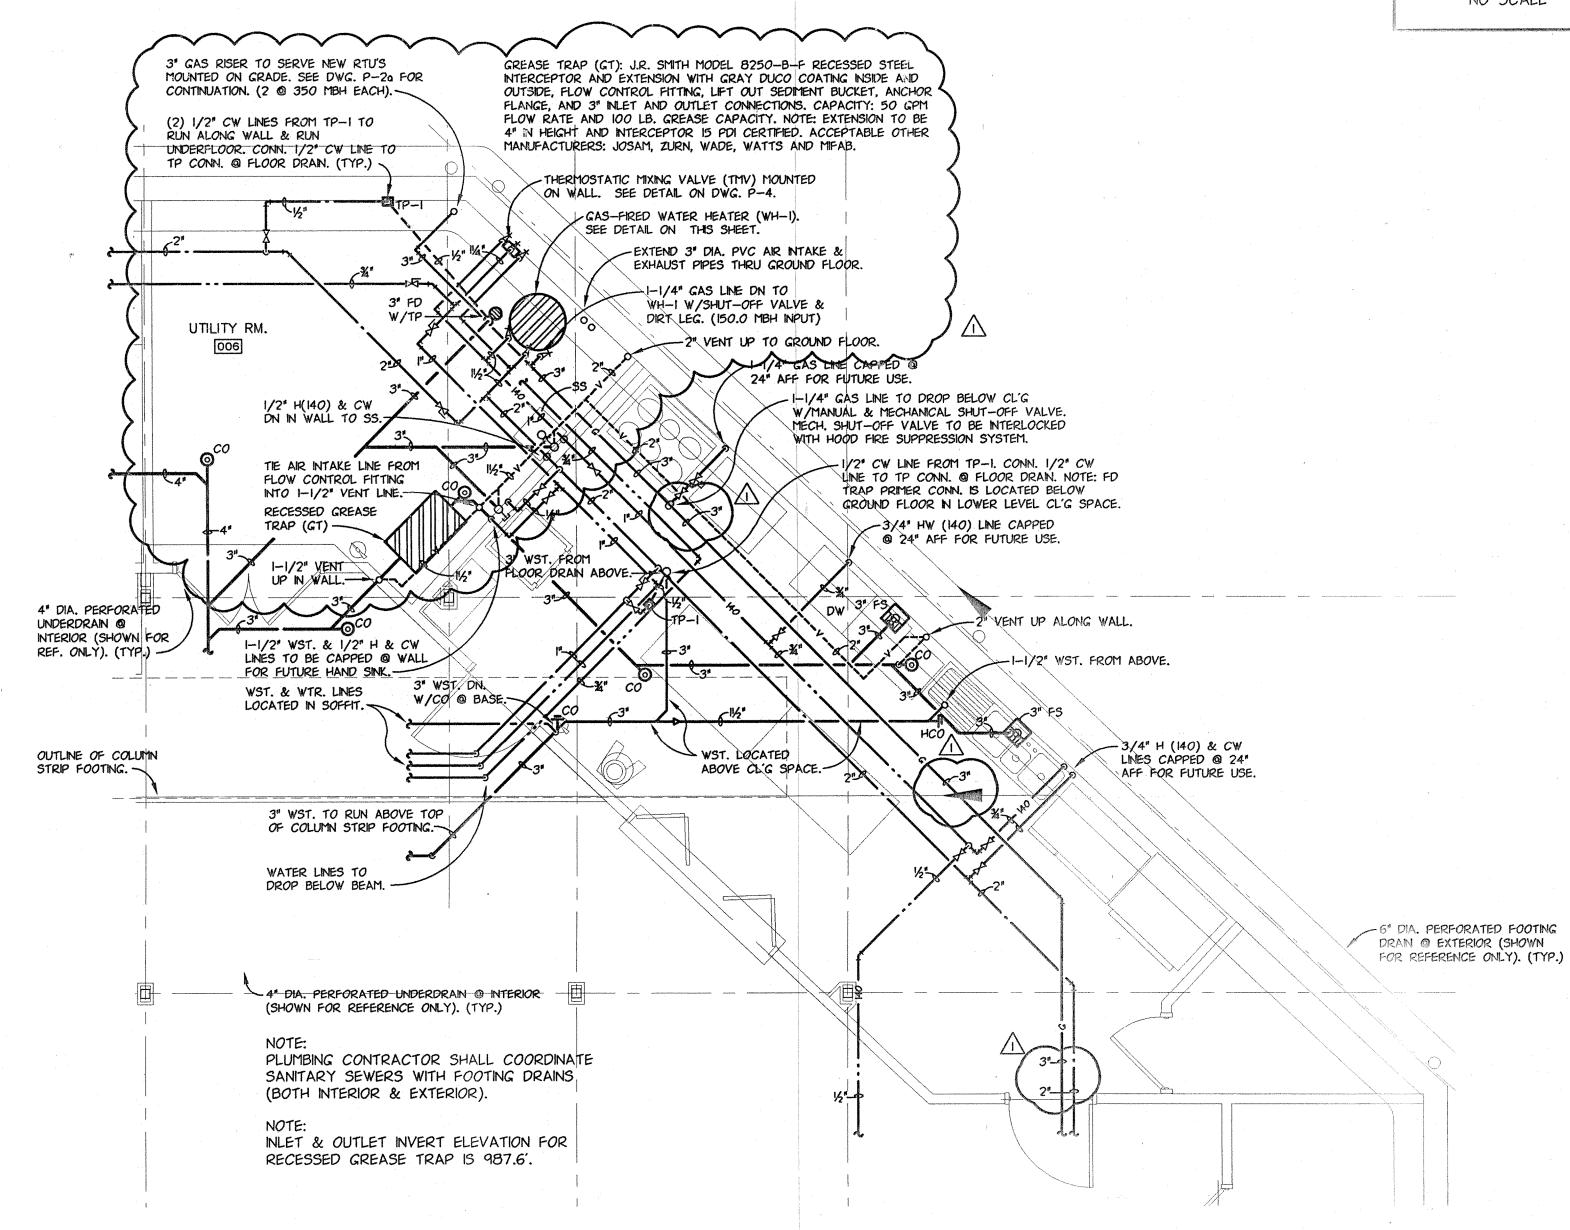
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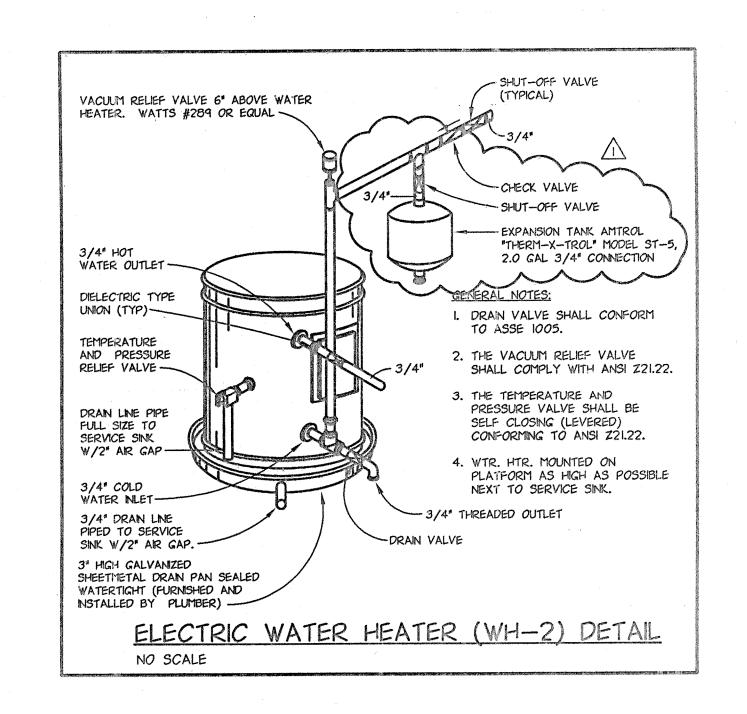
columbus@pointonedesign.com


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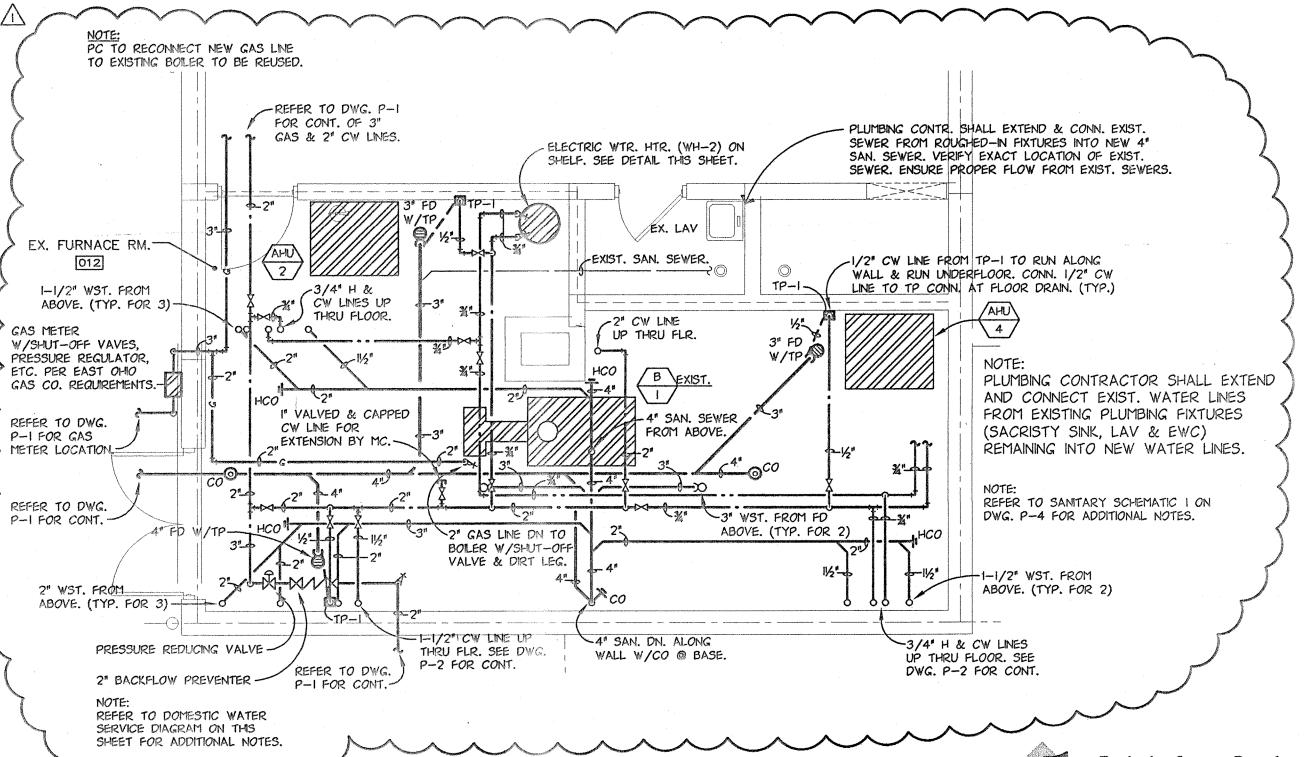




RECIRCULATING HOT -1-1/2" COLD WATER SUPPLY WATER PUMP--SHUT-OFF COCK - EXPANSION TANK AMTROL BALL VALVE (TYP.) ---"THERM-X-TROL" MODEL ST-12, 4.4 GAL., I' CONNECTION DIELECTRIC TYPE UNIONS (TYPICAL) -RECIRCULATING HOT WATER PUMP: B & G MODEL PL-30B, IN-LINE ALL 1-1/2" HW OUTLET-BRONZE PUMP. CAPACITY: 2 GPM @ PRESSURE RELIEF VALVE 20 FT. HD., 1/12 HP, 115V, 1 PHASE, 1.4 FLA, 2650 RPM. -I" RELIEF PIPED FULL SIZE TO FULL DRAIN. -1-1/2" CW INLET GAS FIRED HOT WATER HEATER (WH-I) PIPING DETAIL



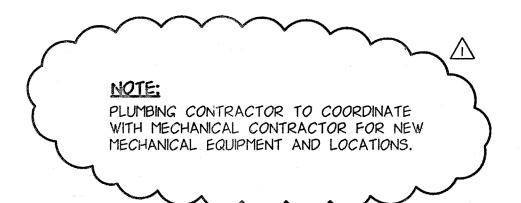

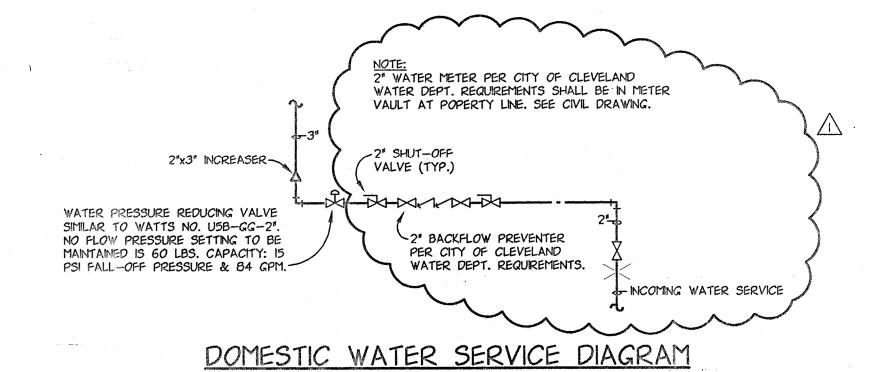

NO SCALE

ENLARGED EX. FURNACE RM. PLUMBING PLAN

SCALE: 1/4'' = 1'-0''

Consulting Engineers

440-230-1800 Fax 440-230-1831 cleveland@pointonedesign.com

HERBERT E-53288

REVISIONS:

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PROJECT NUMBERS OAI3-ELC .05-10-05 . . . MLP. . .

1/4"=1'-0" SHEET NO.:

933 High Street, Suite 106 Worthington, Ohio 43085 614-540-3500 Fax 614-540-3502 columbus@pointonedesign.com

ENLARGED KITCHEN/UTILITY RM. PLUMBING PLAN

SCALE: 1/4" = 1'-0"